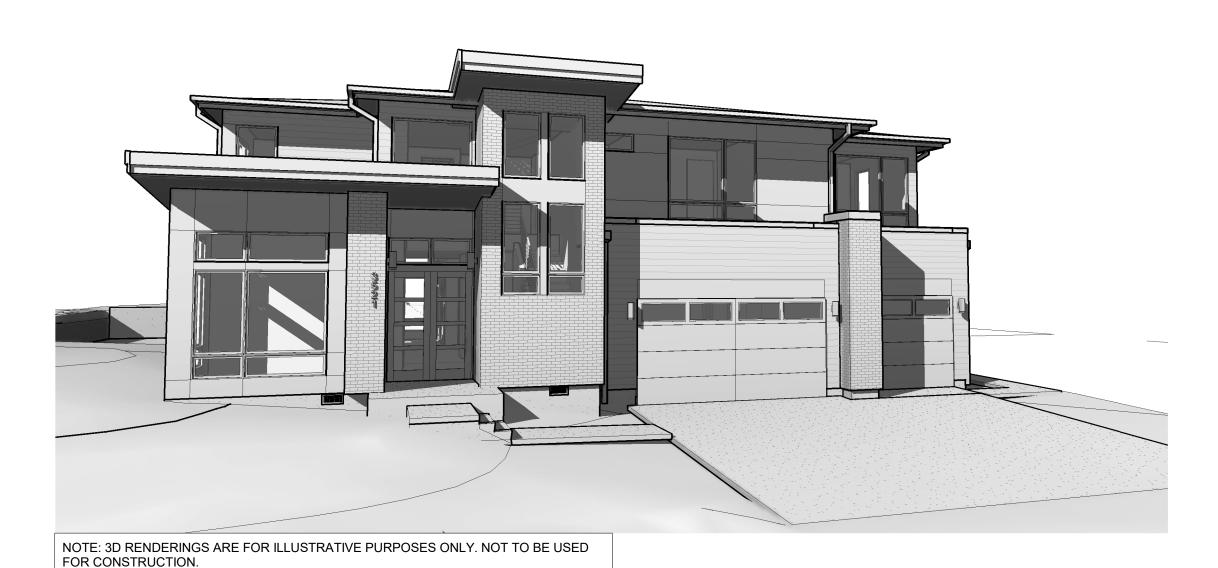
LYNNWOOD HOUSE 1



ABE	BREVIATIONS
AFF	ABOVE FINISH FLOOR AIR CONDITIONING
	AIR CONDITIONING AIR HANDLING UNIT
	ALTERNATE
ALUM	ALUMINUM
ANOD	ANODIZED BASEMENT
BSMT	BASEMENT BLOCK
	BOTH SIDES
	BUILDING
CAB	CABINET
CB	CABINET CATCH BASIN
	CEILING
	CLEAR
CONC	CLOSET CONCRETE CONCRETE MASONRY UNIT
CMU	CONCRETE MASONRY UNIT
CONT	CONTINUOUS
CJ	CONTROL JOINT
CPT	CARPET
CSMT	CASEMENT
CF DIA	CUBIC FOOT DIAMETER
DIA	DIAMETER DIAMETER BREAST HEIGHT
	DIMENSION
	DISHWASHER
DH DN	DOUBLE HUNG
DN	DOWN
DS	
D EA	DRYER EACH
EA FLFC	ELECTRICAL
EP	ELECTRICAL ELECTRICAL PANEL
ELEV	ELEVATOR
	EQUAL
EXT	EXTERIOR
EXIST	EXISTING
FRD	FINISH FLOOR ELEVATION FIRE RATE DOOR
FRW	
FXD	FIXED
FIXT	FIXTURE
FAR	FLOOR AREA RATIO
FTG	FOOTING
FAU	FORCED AIR UNIT
	FOUNDATION FURNACE
	GROSS FLOOR AREA
	HARDWOOD
	HEADER
	HEATING, VENTILATION & A/C
HT	HEIGHT

HORZ HORIZONTAL

HOUR

LF LINEAR FEET

MECH MECHANICAL

MAX MAXIMUM

MED MEDIUM

MANUF MANUFACTURER

MINIMUM

MISC MISCELLANEOUS

NUMBER

PERF PERFORATED

ON CENTER

NOT IN CONTRACT

NOT TO SCALE

LED

NTS

NO

OC

INTERIOR

INCLUDE (ED)(ING)

LOD LIMIT OF DISTURBANCE

LIGHT EMITTING DIODE

RM

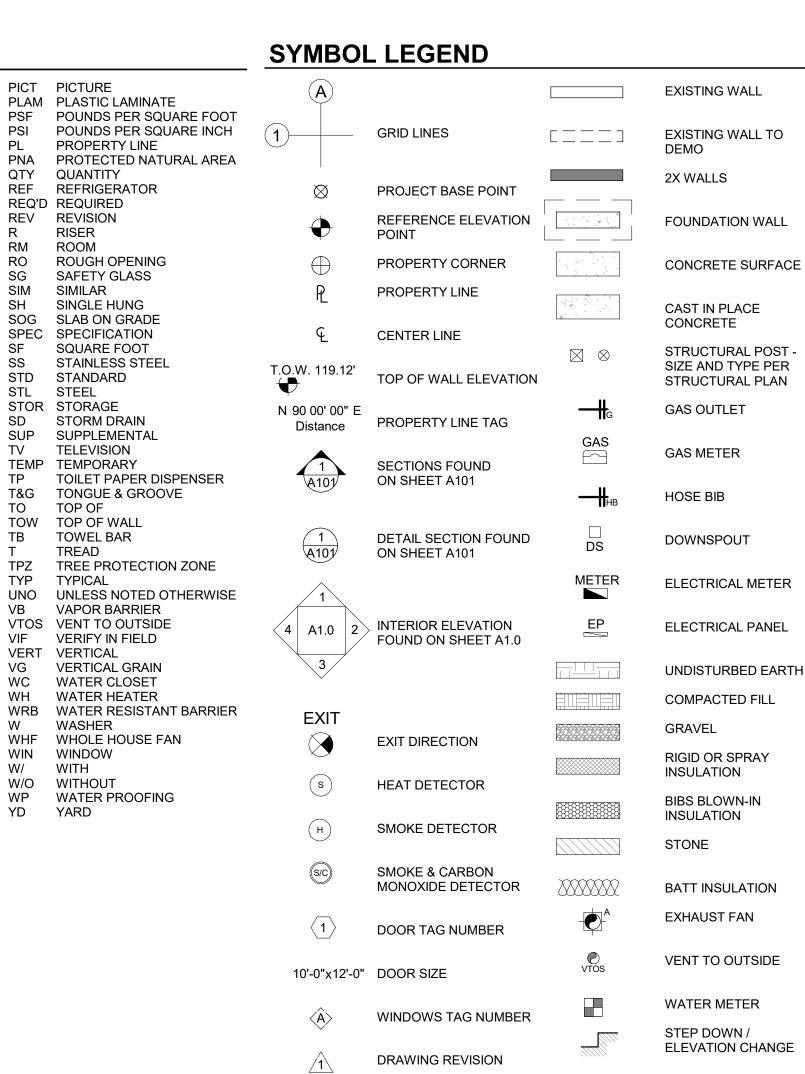
SIM

SS

TO

WITH

W/



WALL TAG ASSEMBLY

WHOLE HOUSE FAN

CONTROL

ENERGY CODE COMPLIANCE - SFR

	CONDITIONED FLOOR AREA 1ST FLOOR: 1,521.11 SF 2ND FLOOR: 2,229.36 SF TOTAL: 3,750.47 SF < 5,000 SF "MEDIUM DWELLING UNIT"	
	GENERAL PRESCRIPTIVE METHOD: SEE SHEETS A0.	3 & A5.0
	FUEL NORMALIZATION CREDITS PER TABLE R406.2 SYSTEM TYPE 2 CREDITS -HEAT PUMP	1.0
	ENERGY CREDITS PER TABLE R406.3 OPTION 1.3 BUILDING ENVELOPE -VERTICAL FENESTRATION U=0.28 -FLOOR R-38	0.5
	-SLAB R-10 AT PERIMETER AND UNDER ENTIRI OPTION 2.2 AIR LEAKAGE CONTROL -AIR LEAKAGE TO MAX 2.0 AIR CHANGES PER HOUR	≣ 1.0
	-WHOLE HOUSE VENTILATIONS SHALL BE MET WITH HRV MIN. SENSIBLE HEAT RECOVERY EFF. OF 0.65	-
	OPTION 3.5 HIGH EFF. HVAC EQUIPMENT -CENTRALLY DUCTED HEAT PUMP WITH MIN HSPF OF 11.0	1.5
	OPTION 4.1: HIGH EFFICIENCY HVAC DISTRIBUTION -AIR HANDLING UNIT TO BE LOCATED IN COND SPACE	ITIONED
I	-DUCT LEAKAGE LIMITED TO 3 CFM PER 100 SI OF CONDITIONED FLOOR AREA OPTION 5.1 EFFICIENT WATER HEATING -A DRAIN WATER HEAT RECOVERY UNIT WILL BE INSTALLED FOR EQUAL FLOW WITH MIN.	0.5
	EFF. OF 40% OPTION 5.3 EFFICIENT WATER HEATING -ENERGY STAR RATED GAS WATER HEATER WITH MIN. UEF OF 0.91.	1.0

SPRINKLER THRESHOLD: 5000 SF **COVERED ENTRY** 53.77 SF **COVERED PATIO** 277.15 SF 1ST FLOOR 1,873.61 SF 2ND FLOOR 2,035.79 SF **GARAGE** 1,042.85 SF **TOTAL** 5,283.17 SF

6.0

AUTOMATIC SPRINKLERS PROVIDED: NFPA 13D *SPRINKLER UNDER A SEPARATE PERMIT

TOTAL CREDITS REQUIRED

TOTAL CREDITS PROPOSED

FIRE CALCULATION

KEY NOTES

PROJECT DATA

CIVIL ENGINEER:

PROJECT DESCRIPTION: NEW CONSTRUCTION OF SINGLE

FAMILY RESIDENCE WITH ATTACHED ACCESSORY DWELLING UNIT AND

ATTACHED GARAGE.

OWNER: TRIAD HOMES

GILL SUKHWINDER 19707 44TH AVE W LYNNWOOD, WA 98036 P: 425.780.1820

E: GILL@TRIADHOMES.NET

ARCHITECT: MEDICI ARCHITECTS JEN KIM

11711 SE 8TH ST, SUITE 100

BELLEVUE, WA 98005 P: 425.453.9298

E: JENN@MEDICIARCHITECTS.COM

STRUCTURAL ENGINEER: UPSTATE ENGINEERING INC.

ANDY GAHAN 22002 64TH AVE W SUITE 2C MOUNTLAKE TERRACE, WA 98043 P: 206.280.4715

E: ANDY@UPST8.COM

TATU CONSULTING ENGINEERS SHAILESH TATU

18402 46TH PL W LYNNWOOD, WA 98037

P: 206.900.4899 E: SHAILESH TATU@HOTMAIL.COM

SURVEYOR: DALEY-MORROW-POBMETE, INC.

> **JUSTIN EMERY** 726 ABURN WAY NORTH **ABYRN, WAY 98002** P: 253.333.2200 E: DMP@DMP-INC.COM

GEOTECH: AMERICAN GEOSERVICES

SAM ADETTIWAR 24 ROY STREET #343 SEATTLE, WA 98109 P: 888.276.4027

E: SMA@AMERICANGEOSERVICES.COM

ENERGY CODE COMPLIANCE - ADU

1ST FLOOR: 617.71 SF < 1,500 SF

TOTAL FENISTRATIONS 94.5 SF "SMALL DWELLING UNIT"

GENERAL PRESCRIPTIVE METHOD: SEE SHEETS A0.3 & A5.0

FUEL NORMALIZATION CREDITS PER TABLE R406.2 SYSTEM TYPE 2 1.0

CREDITS

ENERGY CREDITS PER TABLE R406.3 OPTION 1.3 BUILDING ENVELOPE 0.5 -VERTICAL FENESTRATION U=0.28 -FLOOR R-38

-SLAB R-10 AT PERIMETER AND UNDER ENTIRE OPTION 2.2 AIR LEAKAGE CONTROL -AIR LEAKAGE TO MAX. 2.0 AIR CHANGES PER

HOUR -WHOLE HOUSE VENTILATION SHALL BE MET WITH HRV. MIN. SENSIBLE HEAT RECOVERY EFF. OF .65

OPTION 5.3 EFFICIENT WATER HEATING 1.0 -ENERGY STAT RATED GAS WATER HEATER WITH MIN. UEF OF 0.91. (TANKLESS)

3.0 TOTAL CREDITS REQUIRED 3.5 **TOTAL CREDITS PROPOSED**

CODE INFORMATION

ALL MATERIALS, WORKMANSHIP, DESIGN AND CONSTRUCTION SHALL CONFORM TO THE DRAWINGS, SPECIFICATIONS, AND THE FOLLOWING APPLICABLE CODES USED IN THIS DESIGN FOR CITY OF <u>LYNNWOOD</u>.

2018 WASHINGTON STATE RESIDENTIAL CODE (IRC) 2018 WASHINGTON STATE MECHANICAL CODE (INC) 2018 INTERNATIONAL FUEL GAS CODE (NATURAL GAS) (IFGC) 2018 NATIONAL FUEL GAS CODE 58 (PROPANE) (NFPA 54) 2018 INTERNATIONAL SWIMMING POOL AND SPA CODE (ISPSC) 2018 UNIFORM PLUMBING CODE (UPC)

2018 WASHINGTON STATE ENERGY CODE - RESIDENTIAL PROVISIONS (WSEC - RESIDENTIAL) 2018 WASHINGTON STATE FIRE CODE (IFC) 2020 WASHINGTON CITIES ELECTRICAL CODE



PROJECT LOCATION

VICINITY MAP 1/4" = 1'-0"



INDEX OF DRAWINGS

TITLE SHEET & SYMBOLS

1 OF 1 SURVEY

ARCHITECTURAL SHEET INDEX

SITE PLAN FOUNDATION PLAN A1.0 1ST FLOOR PLAN A2.1 2ND FLOOR PLAN A3.0 ROOF PLAN

A4.0 **ELEVATIONS** A4.1 **ELEVATIONS** A4.2 **PERSPECTIVES**

A4.3 **ELEVATIONS-MATERIALS / COLORS ELEVATIONS-MATERIALS / COLORS**

MEDICI ARCHITECTS 11711 SE 8TH STREET 200 W. RIVER ST. SUITE 100 SUITE 301

TEL: (425) 453-9298

REGISTRATION:

BELLEVUE, WA 98005

REGISTERED ARCHITECT JENNIFER J. U. KIM STATE OF WASHINGTON

KETCHUM, ID 83340

TEL: (208) 726-0194

INTAKE DATE:	07-26-	
REVISIONS:	DATE:	

PROJECT / CLIENT:

LYNNWOOD HOUSE 2

TRIAD HOMES

PROJECT ADDRESS: 3521 169TH AVE SW

LYNNWOOD, WA 98037

DRAWING NAME:

TITLE SHEET

DRAWN BY: KKH CHECKED By: JK

PHASE:

ADU LAND USE PERMTI

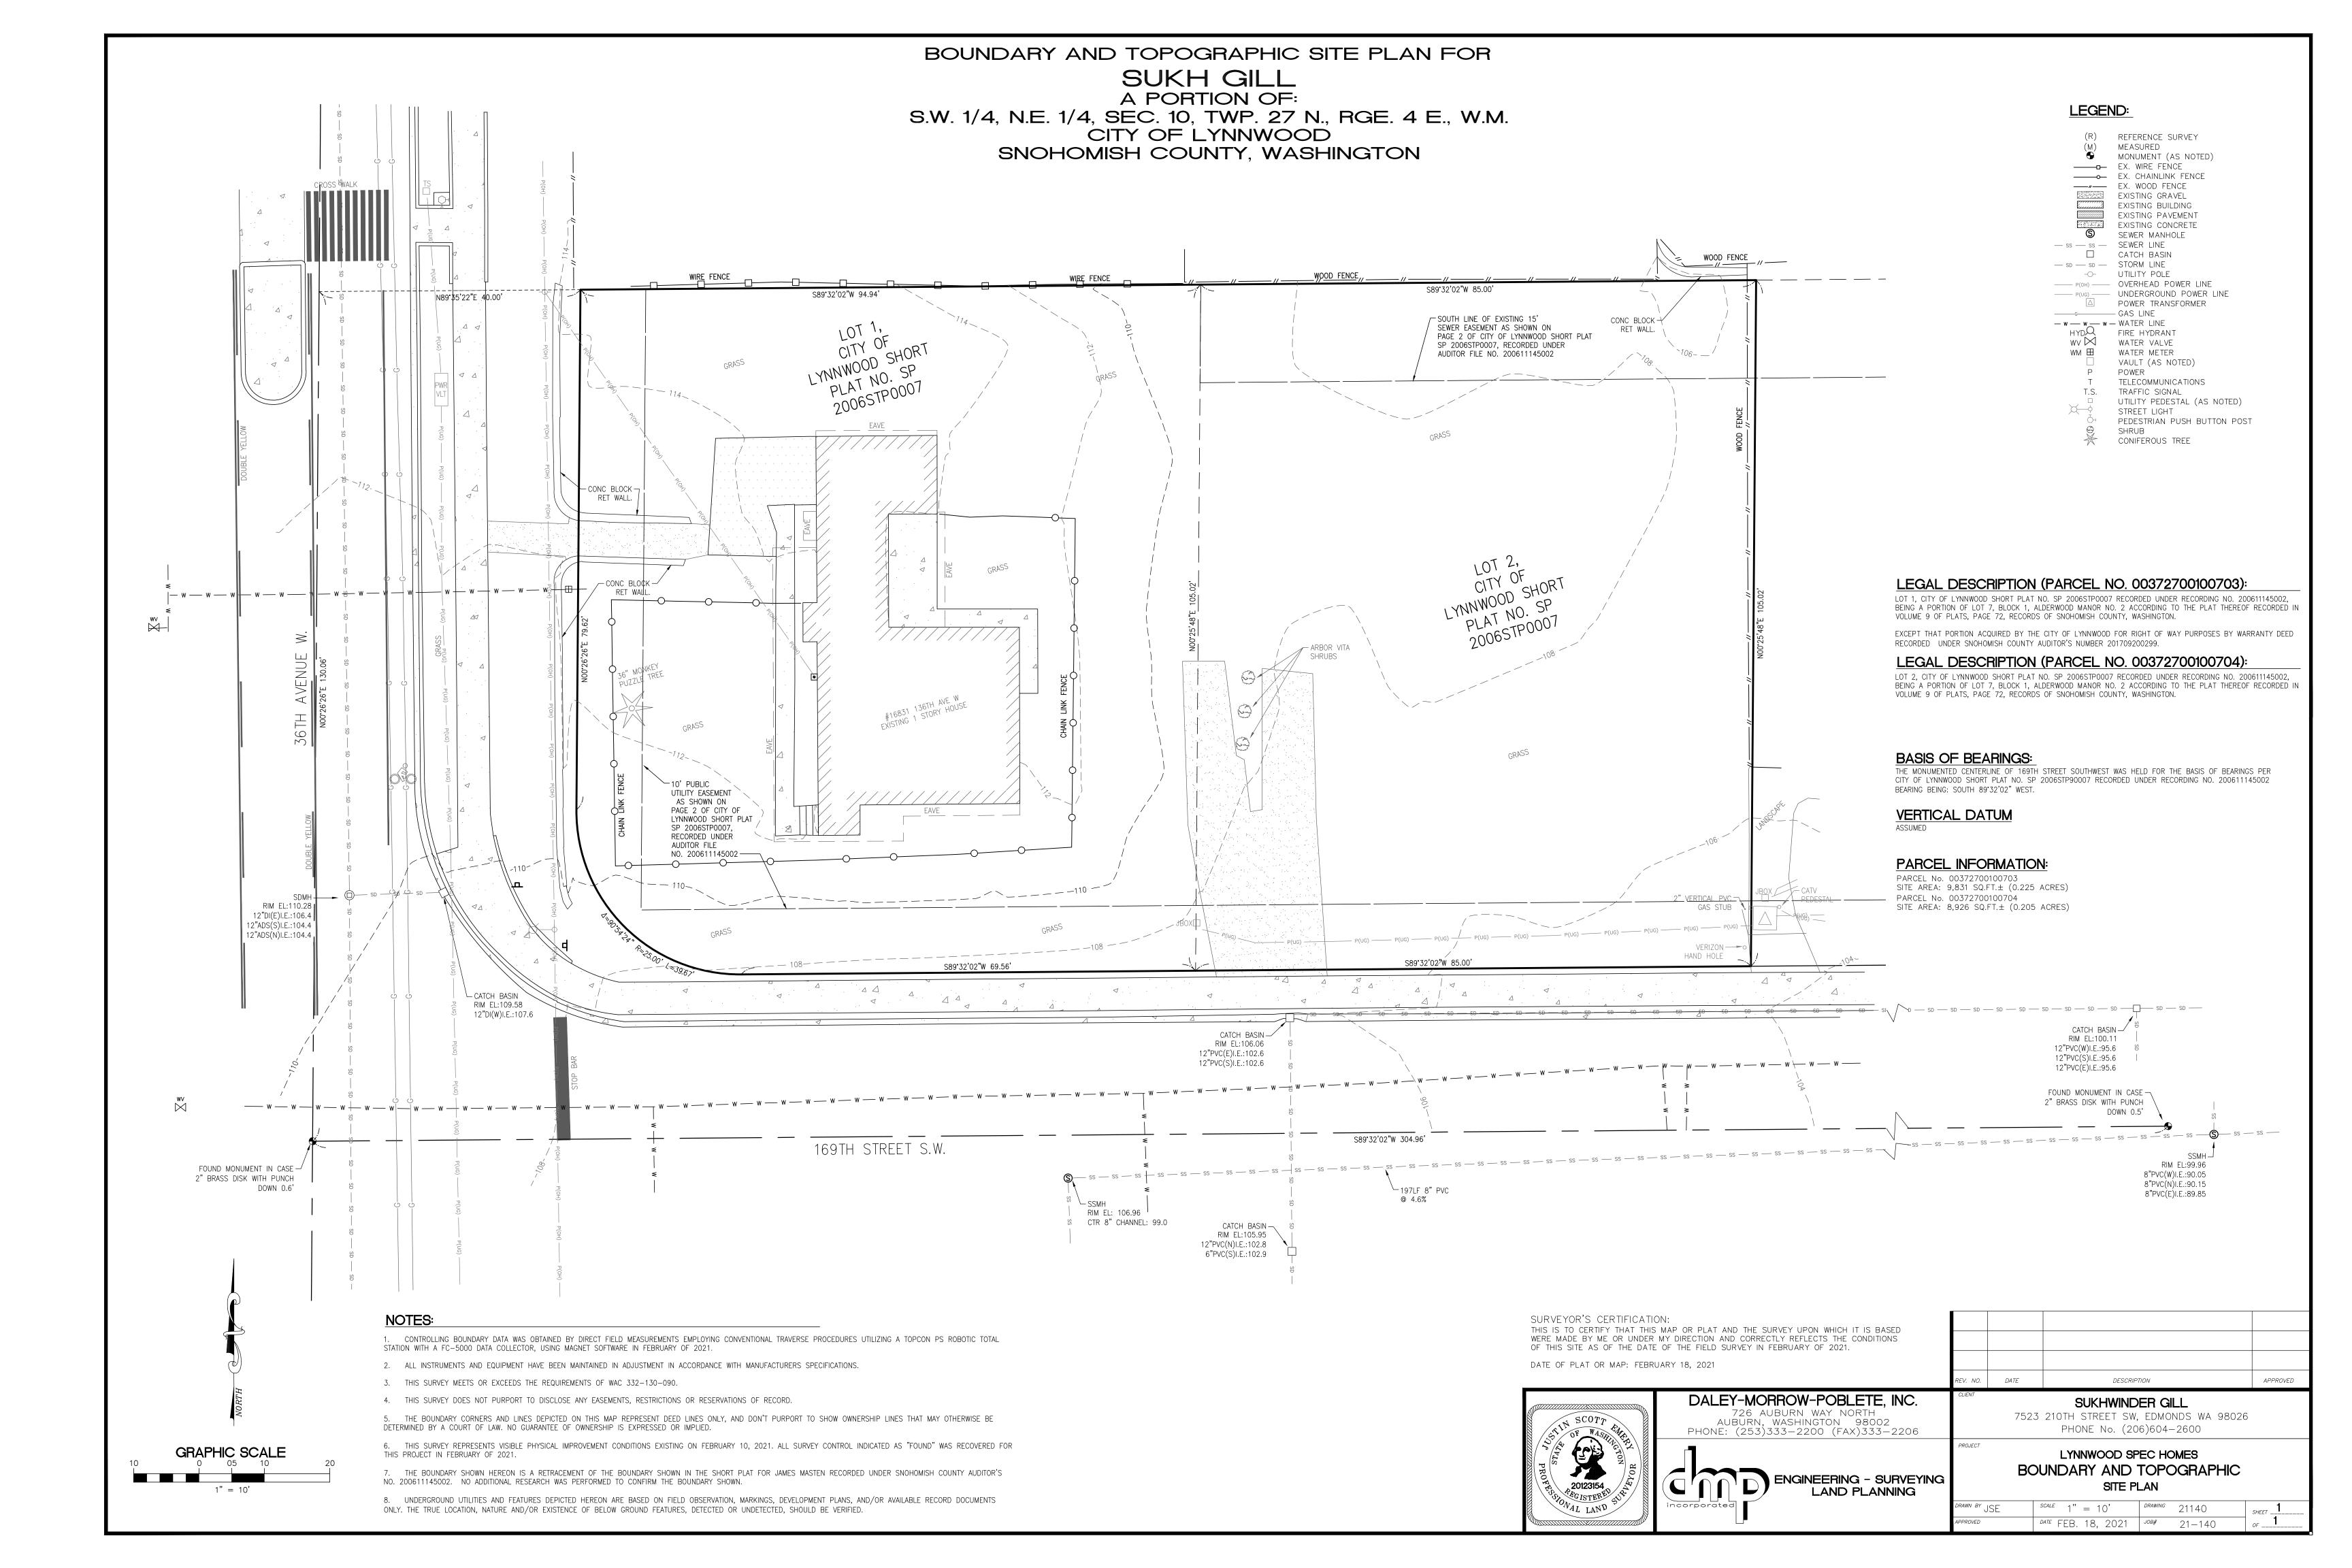
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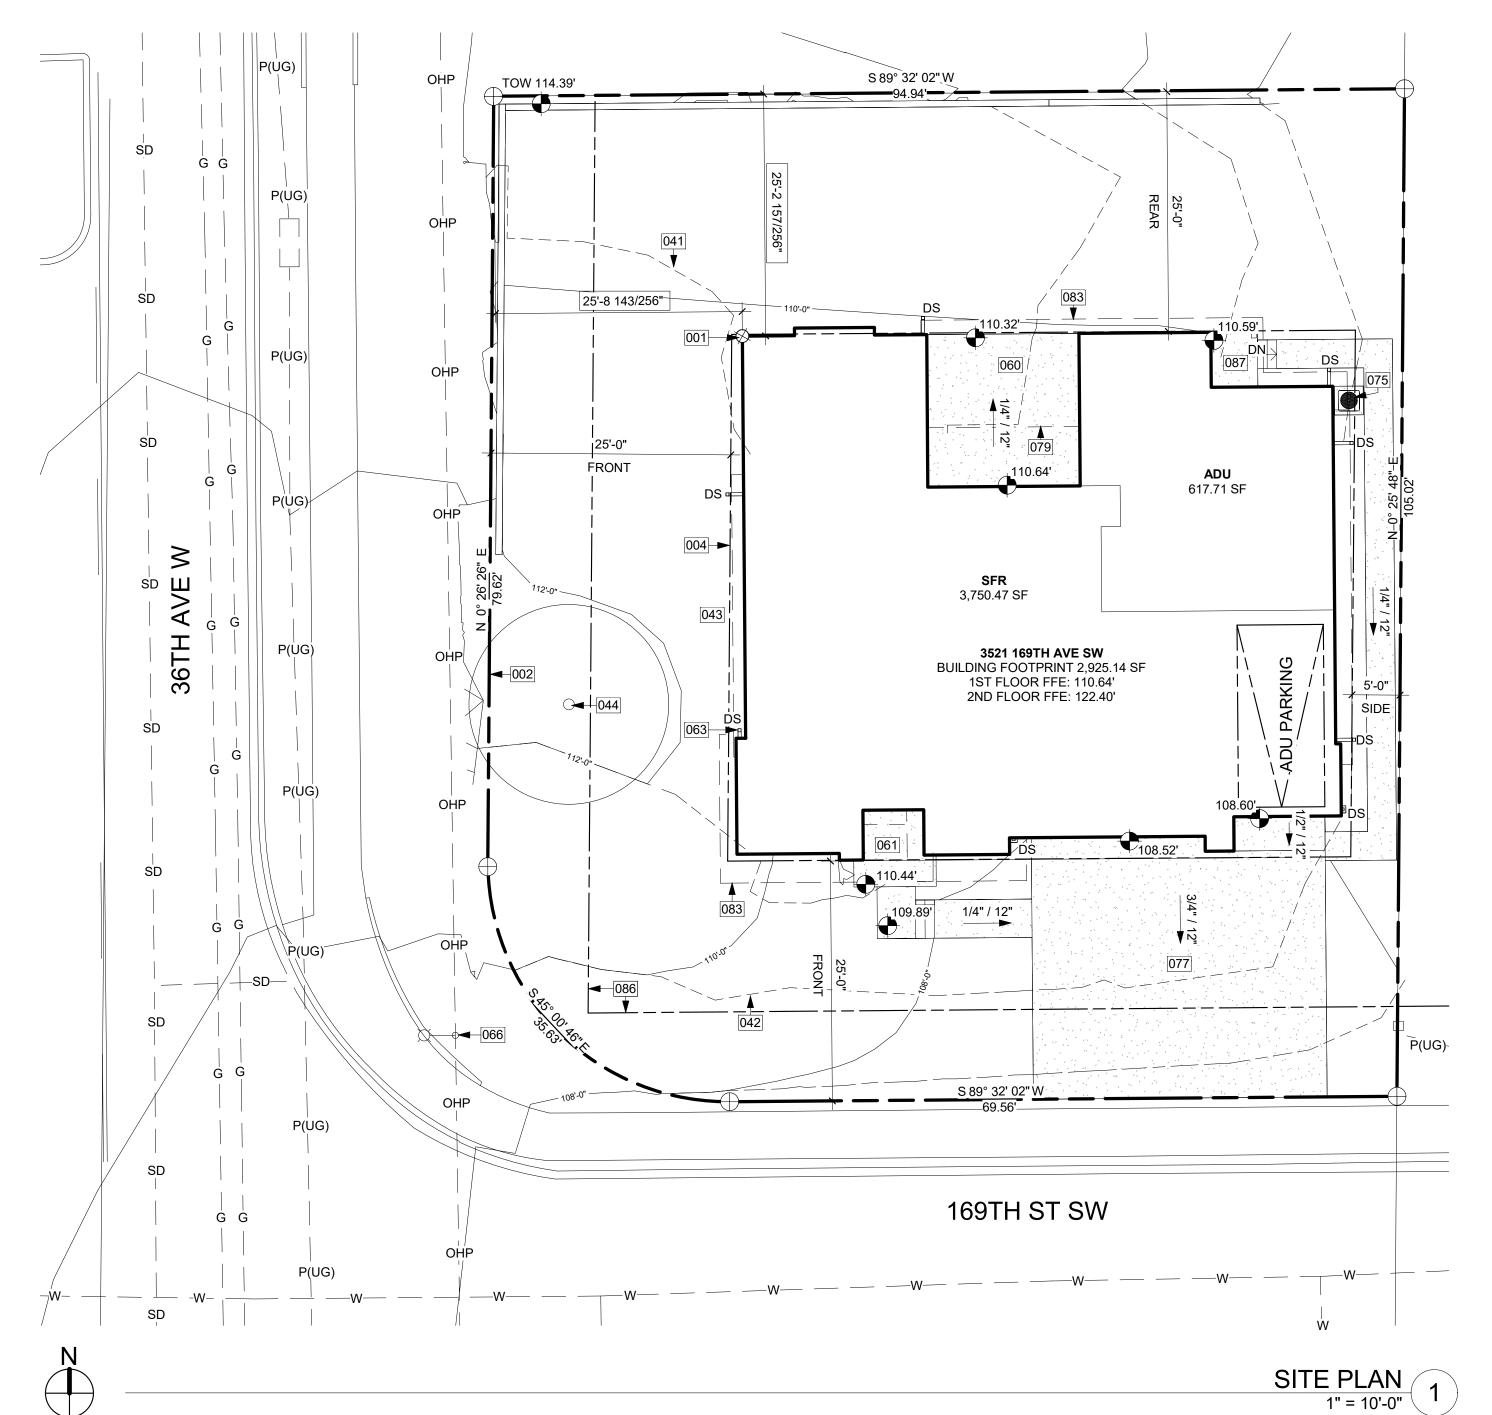
APPROVED FOR CONSTRUCTION:


DEFERRED SUBMITTAL

THE FOLLOWING ITEMS ARE CONSIDERED TO BE A DEFERRED SUBMITTAL UNDER SECTION 107.3.4.1 OF THE IBC AND MUST BE SUBMITTED TO THE ENGINEER FOR REVIEW. THESE ITEMS WILL THEN BE FORWARDED TO THE BUILDING OFFICIAL FOR APPROVAL. THE DEFERRED SUBMITTAL ITEMS SHALL NOT BE INSTALLED UNTIL THE DESIGN AND SUBMITTAL DOCUMENTS HAVE BEEN APPROVED BY THE BUILDING OFFICIAL. *HANDRAILS *GUARDRAILS

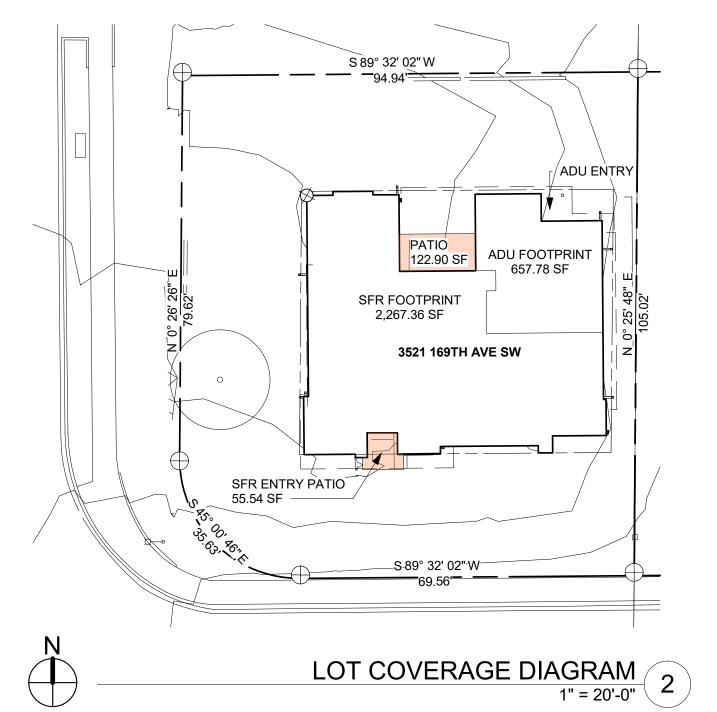PROJECT No.: A21 069 DATE: 7/26/2023







KEY NOTES

001	PROJECT BASE POINT.
002	EXISTING PROPERTY LINE.
004	SETBACK LINE.
041	LINE OF EXISTING GRADE, PER SURVEY.
042	LINE OF PROPOSED GRADE, PER CIVIL.
043	GRADE SITE AWAY FROM BUILDING, PER IRC 401.3.
044	EXISTING TREE TO REMAIN. PROTECT PER ARBORIST.
060	PROPOSED AT-GRADE CONCRETE PATIO, PER PLANS.
061	FRONT ENTRY TO SFR.
063	DOWNSPOUT, STORMWATER SYSTEM PER CIVIL.
066	EXISTING POWER POLE
075	CONCRETE SLAB OVER COMPACTED EARTH FOR OUTDOOR HVAC UNIT, O
	PER MANUFACTURER'S RECOMMENDATION.
077	DRIVEWAY SLOPE PER CIVIL.
079	LINE OF BUILDING ABOVE.

LINE OF 10' PUBLIC UTILITY EASEMENT PER SURVEY. 00 SITE PLAN

ZONING REQUIREMENTS

LINE OF ROOF OR AWNING ABOVE.

JURISDICTION: CITY OF LYNNWOOD RS-8 ZONING: 00372700100703 PARCEL ASSESSOR'S #: LOT SIZE: 9,831 SF = 0.225 ACRE

LEGAL DESCRIPTION:

SECTION 10 TOWNSHIP 27 RANGE 04 QUARTER NE ALDERWOOD MANOR 2 BLK 001 D-03-LOT 1 CITY OF LYN SP 2006STP0007 REC AFN 200611145002 LESS RD R/W TO CITY OF LYN PER WD REC AFN 201709200299

MAXIMUMS: MAX. FAR: N/A

MAX. LOT COVERAGE: 35% (3,440.85 SF) MAX. HEIGHT: 35' ABOVE ABE

MIN. 25' PROVIDED: 25' **REQUIRED SIDE:** MIN. 5'/10' PROVIDED: 5' REQUIRED REAR: MIN. 25' PROVIDED: 25'

MAX ADU HABITABLE AREA:

SFR HABITABLE AREA: 3,750.74 SF 1,500.30 SF

40% OF SFR:

800.00 SF PROVIDED: 617.71 SF MAX ADU AREA:

NOTE:

THE ACCESSORY DWELLING UNIT SHOWN ON THIS PLAN SHALL NOT BE SOLD AS A SEPARATE PROPERTY OR AS A CONDOMINIUM, OR IN ANY WAY BE PART OF A SUBDIVISION OF THE LOT UPON WHICH IT IS LOCATED UNLESS THAT SUBDIVISION CONFORMS WITH ALL PROVISIONS OF THE LYNNWOOD MUNICIPAL CODE

LOT COVERAGE CALCULATION

TOTAL:	3,103.58 S
PERCENT:	31.57%
BUILDING FOOTPRINT - SFR	2,267.36 S
BUILDING FOOTPRINT - ADU	657.78 S
SFR ENTRY PATIO	55.54 S
REAR PATIO	122.90 S
LOT SIZE	9,831 S
ALLOWABLE COVERAGE (35%)	3,440.85 S

TREE PROTECTION GUIDELINES

ALL REMAINING TREES ARE TO HAVE A TREE PROTECTION ZONE (TPZ) ESTABLISHED BEFORE COMMENCEMENT OF ANY CONSTRUCTION OR DELIVERY ACTIVITIES. THE FOLLOWING GUIDELINES ARE TO BE OBSERVED AND PRACTICED DURING ALL CONSTRUCTION ACTIVITIES.

- ACCESS IS TO BE RESTRICTED INTO TPZ'S WITH READILY VISIBLE TEMPORARY TREE FENCING ALONG THE LOD WHICH COMPLETELY SURROUNDS THE PROTECTED AREAS OF RETAINED TREES. FENCES SHALL BE CONSTRUCTED OF CHAIN LINK AND BE AT LEAST 4 FT TALL, CONSTRUCTED USING PIER BLOCK, AND MAJOR ROOTS SHOULD BE AVOIDED WHILE STAKING.
- HIGHLY VISIBLE SIGNS SPACED NO FURTHER THAN 15 FEET SHALL BE PLACED ALONG SIDES OF THE TPZ
- CONSTRUCTION MATERIALS OR SUPPLIES, SOIL, DEBRIS VEHICLES, AND EQUIPMENT ARE NOT TO BE PARKED OR STORED WITHIN TPZ.
- TPZ FENCES MUST BE INSPECTED PRIOR TO THE BEGINNING OF ANY CONSTRUCTION ACTIVITIES.
- ASSESS CREW AND CONTRACTOR PENALTIES, IF NECESSARY, TO KEEP THE TPZ'S INTACT.
- CHECK THE INTEGRITY OF TPZ FENCES WEEKLY, AND REPAIR OR REPLACE AS NEEDED.
- WOOD CHIPS SHOULD BE USED IF POSSIBLE TO SPREAD ABOVE ROOT ZONES WITHIN THE TPZ'S TO A DEPTH OF
- 6-8 INCHES FOR TEMPORARY PROTECTION. CEMENT TRUCKS MUST NOT DEPOSIT WASTE OR RINSE OUT TRUCKS IN THE TPZ.
- AVOID GRADE CHANGES OR TRENCHING WITHIN OR NEAR THE TPZ. IF IT IS UNAVOIDABLE, THEN FOLLOW THE GUIDELINES BELOW.
- TPZ'S MAY ONLY BE MOVED OR ACCESSED WITH PERMISSION FROM CITY OFFICIALS, AND ANY WORK DONE WITHIN TPZ'S MUST BE DONE WITH A CERTIFIED ARBORIST PRESENT.
- IF ROOTS NEED TO PRUNED, THEY SHOULD BE CUT WITH PRUNING SAWS, MADE FLUSH WITH THE SIDE OF THE
- TREES SHOULD BE WATERED TWICE A WEEK IF CONSTRUCTION IS TO TAKE PLACE DURING HOT SUMMER MONTHS

IF EXCAVATION OCCURS WITHIN THE DRIPLINES OF TREES SCHEDULED FOR RETENTION, THE FOLLOWING PROCEDURES MUST BE FOLLOWED TO PROTECT THEM:

- THE CONTRACTOR SHALL VERIFY THE VERTICAL AND HORIZONTAL LOCATION OF EXISTING UTILITIES TO AVOID CONFLICTS AND MAINTAIN MINIMUM CLEARANCES; ADJUSTMENT SHALL BE MADE TO THE GRADE OF THE NEW UTILITY AS REQUIRED.
- THE INNER ROOT ZONE SHALL NOT BE DISTURBED OR CUT (INNER ROOT ZONE = HALF THE DRIP LINE RADIUS).
- ISA CERTIFIED ARBORIST MUST WORK WITH EQUIPMENT OPERATORS DURING TRENCHING/ EXCAVATION. THE ARBORIST SHOULD HAVE A SHOVEL, HAND PRUNERS, LOPPERS, HANDSAW, AND A SAWSALL
- IF ROOTS ONE INCH OR LARGER ARE DAMAGED BY EQUIPMENT, THE ARBORIST SHALL STOP THE EQUIPMENT AND HAVE THE DIRT EXCAVATED BY HAND UNTIL THE ROOT CAN BE CLEANLY CUT. A CLEAN STRAIGHT CUT SHALL BE MADE TO REMOVE THE DAMAGED PORTION OF ROOT, AND IF POSSIBLE THE ROOTS SHOULD BE COVERED IN MOIST BURLAP UNTIL RECOVERED WITH DIRT THE SAME DAY.
- BORING OR TUNNELING UNDER ROOTS OF EXISTING TREES IS A VIABLE ALTERNATIVE TO TRENCHING THROUGH ROOTS. IT SHALL BE PERFORMED UNDER THE SUPERVISION OF AN ISA CERTIFIED ARBORIST, AND NO ROOTS 1 INCH IN DIAMETER OR LARGER SHALL BE CUT.
- THE GRADE SHALL NOT BE ELEVATED OR REDUCED WITHIN THE CRITICAL ROOT ZONE OF TREES TO BE PRESERVED WITHOUT THE PLANNING OFFICIAL'S AUTHORIZATION BASED ON RECOMMENDATIONS FROM A QUALIFIED PROFESSIONAL. THE PLANNING OFFICIAL MAY ALLOW COVERAGE OF UP TO ONE HALF OF THE AREA OF THE TREE'S CRITICAL ROOT ZONE WITH LIGHT SOILS (NO CLAY) TO THE MINIMUM DEPTH NECESSARY TO CARRY OUT GRADING OR LANDSCAPING PLANS, IF IT WILL NOT IMPERIL THE SURVIVAL OF THE TREE. AERATION DEVICES MAY BE REQUIRED TO ENSURE THE TREE'S SURVIVAL.

TREE INVENTORY

ONSITE TREES ACTION SIGNIFICANT MONKEY PUZZLE TREE RETAIN

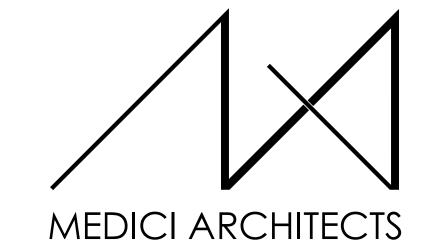
TOTAL SIGNIFICANT TREES TOTAL NON-SIGNIFICANT TREES

* SUPPLEMENTAL TREES TO MEET REQUIRED MINIMUM SIZE WORTH ONE TREE CREDIT AS OUTLINE IN LMC. * 2" CALIPER FOR DECIDUOUS & 6-7 ft. TALL CONIFERS

SYMBOL LEGEND

SEE GENERAL NOTES SHEET A0.0 FOR COMPLETE SYMBOL INDEX.

CALL 48 HOURS **BEFORE YOU DIG** 811 OR <u>1-800-424-5555</u>



11711 SE 8TH STREET SUITE 100 BELLEVUE, WA 98005 TEL: (425) 453-9298

200 W. RIVER ST. SUITE 301 KETCHUM, ID 83340 TEL: (208) 726-0194

REGISTRATION:



INTAKE DATE:	07-26-2023
REVISIONS:	DATE:

PROJECT / CLIENT:

LYNNWOOD HOUSE 2

TRIAD HOMES

PROJECT ADDRESS: 3521 169TH AVE SW

LYNNWOOD, WA 98037

SITE PLAN

DRAWING NAME:

DRAWN BY: KKH CHECKED By: JK


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APPROVED FOR CONSTRUCTION:

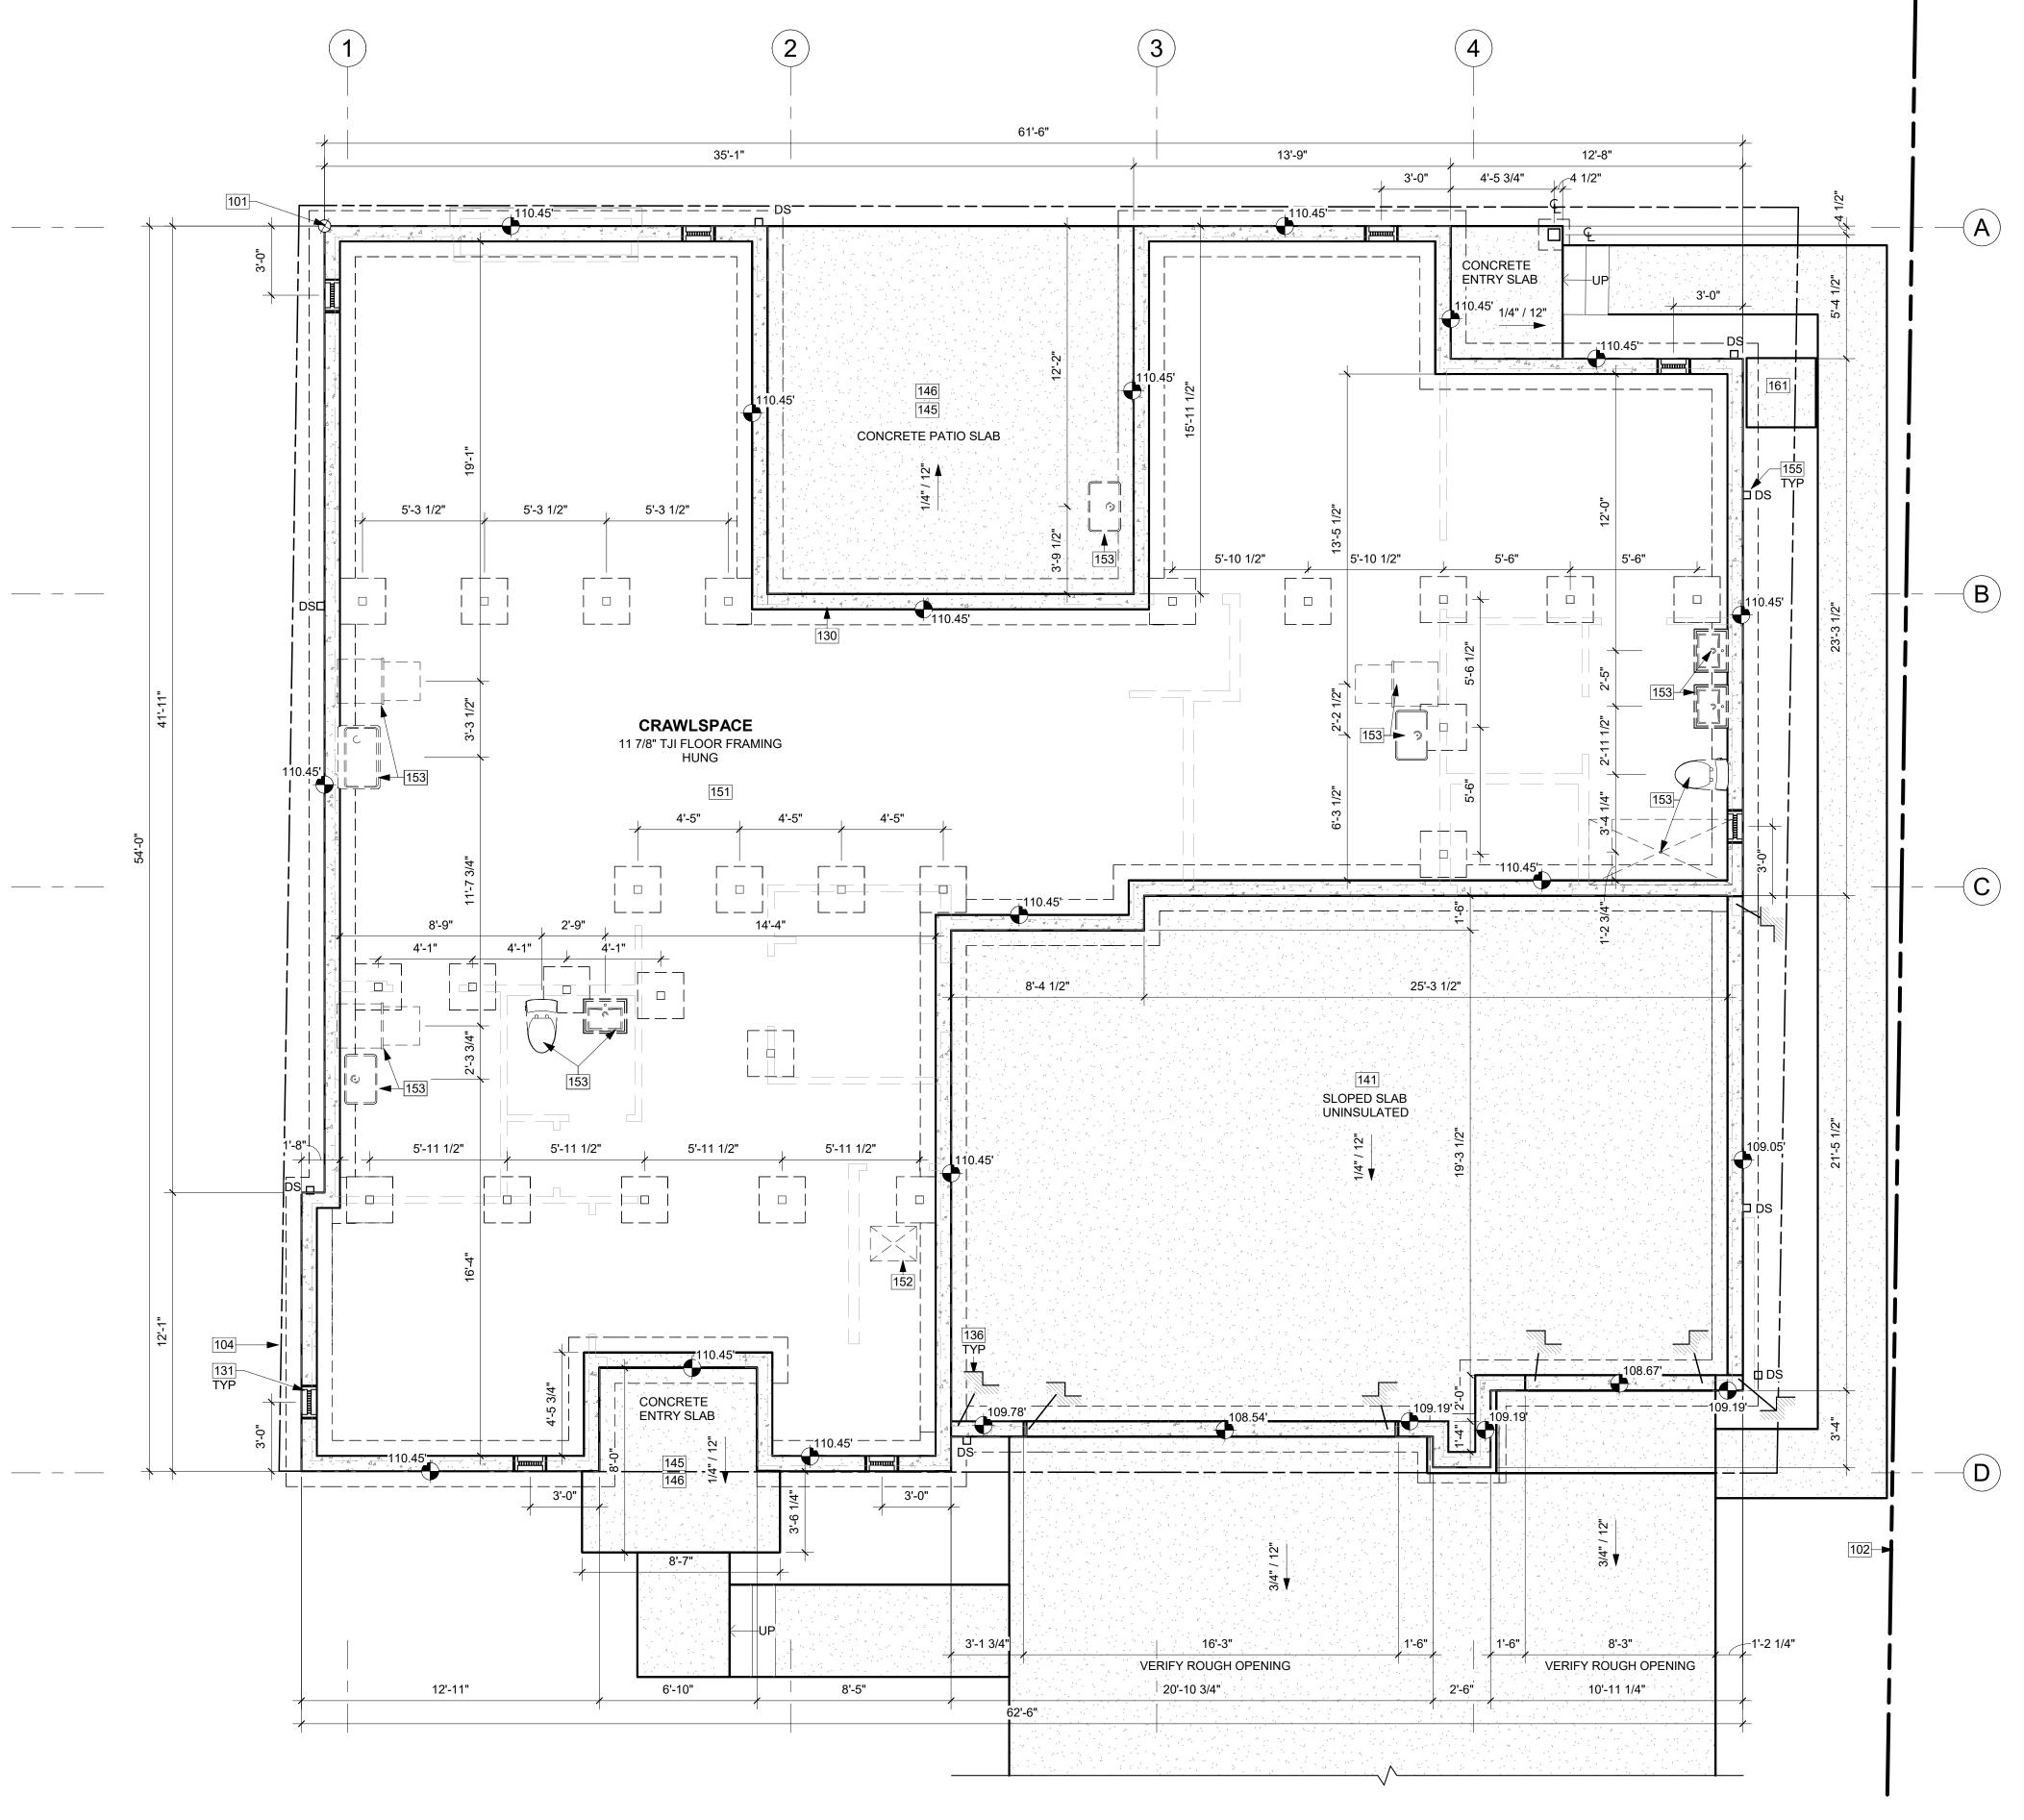PROJECT No.: A21 069 DATE: 7/26/2023








KEY NOTES

101	PROJECT BASE POINT.
102	EXISTING PROPERTY LINE.
104	SETBACK LINE.
130	FOUNDATION WALL AND FOOTING, PER STRUCTURAL. 6MIL VAPOR BARRIER TURNED UP AND OVER TOP OF STEM WALL.
131	16"x8" CRAWL SPACE VENT, TYP. ENSURE VENTS ARE NOT IN CONFLICT WITH HOLDDOWNS. PROVIDE PRE-FABRICATED GALVANIZED VENT WELL AS REQUIRED, PER IRC 408.1.
136	STEP IN FOUNDATION WALL, TYP.
141	CONCRETE SLAB IN UNCONDITIONED SPACE. SLOPE PER PLANS. INSTALL OVER GRAVEL OR CRUSHED ROCK OVER FIRM COMPACTED OR UNDISTURBED SOIL, WITH REINFORCING PER STRUCTURAL.
145	CONCRETE LANDING. MIN. SLOPE 1/4" PER 12" AWAY FROM BUILDING.
146	LANDINGS OR FINISHED FLOORS AT REQUIRED EGRESS DOORS SHALL NOT BE MORE THAN 1-1/2" LOWER THAN THE TOP OF THE THRESHOLD.
151	CRAWL SPACE. MINIMUM 18" TALL. PROVIDE MIN 6MIL VAPOR BARRIER OVER GRADE AND TURNED UP AND OVER STEM WALLS.

152 CRAWL SPACE ACCESS IN FLOOR ABOVE, PER IRC R408.4. 18"x24" MIN OPENING WITH R-38 INSULATION.

153 PLUMBING FIXTURE ABOVE. VERIFY DIMENSIONS IN FIELD PER FIXTURE SELECTION.

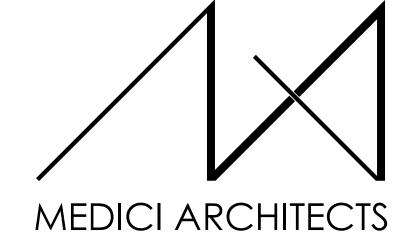
POWDER-COATED 4" SQUARE DOWNSPOUT. TIGHTLINE ALL DOWNSPOUTS TO STORMWATER SYSTEM, PER CIVIL.
 CONCRETE SLAB OVER COMPACTED EARTH FOR OUTDOOR HVAC UNIT, OR PER MANUFACTURER'S RECOMMENDATION.



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200 W. RIVER ST. SUITE 301 KETCHUM, ID 83340 TEL: (208) 726-0194

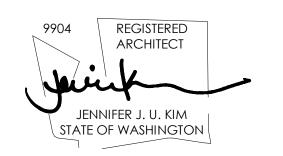REGISTRATION:



INTAKE DATE:	07-26-202	
REVISIONS:	DATE:	

PROJECT / CLIENT:

LYNNWOOD HOUSE 2

TRIAD HOMES

PROJECT ADDRESS: 3521 169TH AVE SW LYNNWOOD, WA 98037

DRAWING NAME:

DRAWN BY: KKH

CHECKED By: JK

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Variations and modifications to work shown on

this drawing shall not be carried out without

PHASE:

FOUNDATION PLAN

CRAWL SPACE VENTILATION

CRAWL SPACE AREA =	1,952.50 SF	
VENTILATION REQUIRED:	(1,952.50 SF x 144 SI) / 1500 =	187.44 SI REQUIRED
USE:	16"x8" FOUNDATION VENTS	
NET VENT AREA =	98.0 SI (-25%) = 73.5 SI	
VENTS REQUIRED =	168.05 SI / 73.5 SI =	3 VENTS
PROVIDE:	(8) 16"x8" VENTS =	588 SI
TOTAL MIN. VENTILATION PROVIDED = 588 SI IS GREATER THAN 187.44 REQUIRED.		
NOTE: MINIMUM 1 SI/150 SF VENTILATION REQUIRED OR 1 SI/1500 SF IF CLASS 1 VAPOR RETARDER OVER ENTIRE GROUND SURFACE IS PROVIDED, PER IRC		

FOUNDATION PLAN NOTES

SECTION R408.1.

- 1. FOOTINGS SHALL BEAR ON SOLID UNDISTURBED EARTH (CONTROLLED, COMPACTED STRUCTURAL FILL OR BOTH). DEPTH OF FOOTINGS TO BE DETERMINED BY STRUCTURAL ENGINEER. FOUNDATION EXCAVATION, BACKFILL AND COMPACTION SHALL CONFORM TO SPECIFICATION REQUIREMENTS. THIS CONSTRUCTION WORK, INCLUDING DRAINAGE, SHORING AND SUCH OTHER RELATED WORK AS REQUIRED, SHALL BE CONDUCTED BY THE CONTRACTOR. STOP WORK IF RECOMMENDED EXCAVATION CUT OR BEARING SOIL CHANGES OCCUR IN EITHER HORIZONTAL OR VERTICAL DIRECTION AND NOTIFY IMMEDIATELY THE GEOTECHNICAL ENGINEER AND STRUCTURAL ENGINEER. AT WHICH POINT THE ENGINEERS SHALL DETERMINE CAUSE OF DISPLACEMENT AND DEVELOP AND IMPLEMENT REMEDIAL MEASURES.
- 2. REFER TO STRUCTURAL PLANS FOR ALL FRAMING & FOUNDATION INFORMATION
- 3. ALL IMPERVIOUS SURFACES TO BE GRADED TO SLOPE AND DRAIN AWAY FROM THE STRUCTURE MIN. 1/4" PER FOOT.

SYMBOL LEGEND


SEE GENERAL NOTES SHEET A0.2 FOR COMPLETE SYMBOL INDEX

SEE GENERA	AL NOTES SHEET AU.2 FOR COMPLETE SYMBOL INDEX.
	WALL ABOVE
	NEW DIAGRAMMATIC FOUNDATION WALL & FOOTING. VERIFY SIZE WITH STRUCTURAL.
	NEW SLAB ON GRADE
	POST AND PLINTH - VERIFY SIZE AND TYPE WITH STRUCTURAL PLAN

TOW 119.12' TOP OF WALL ELEVATION

PROJECT No.: A21 069

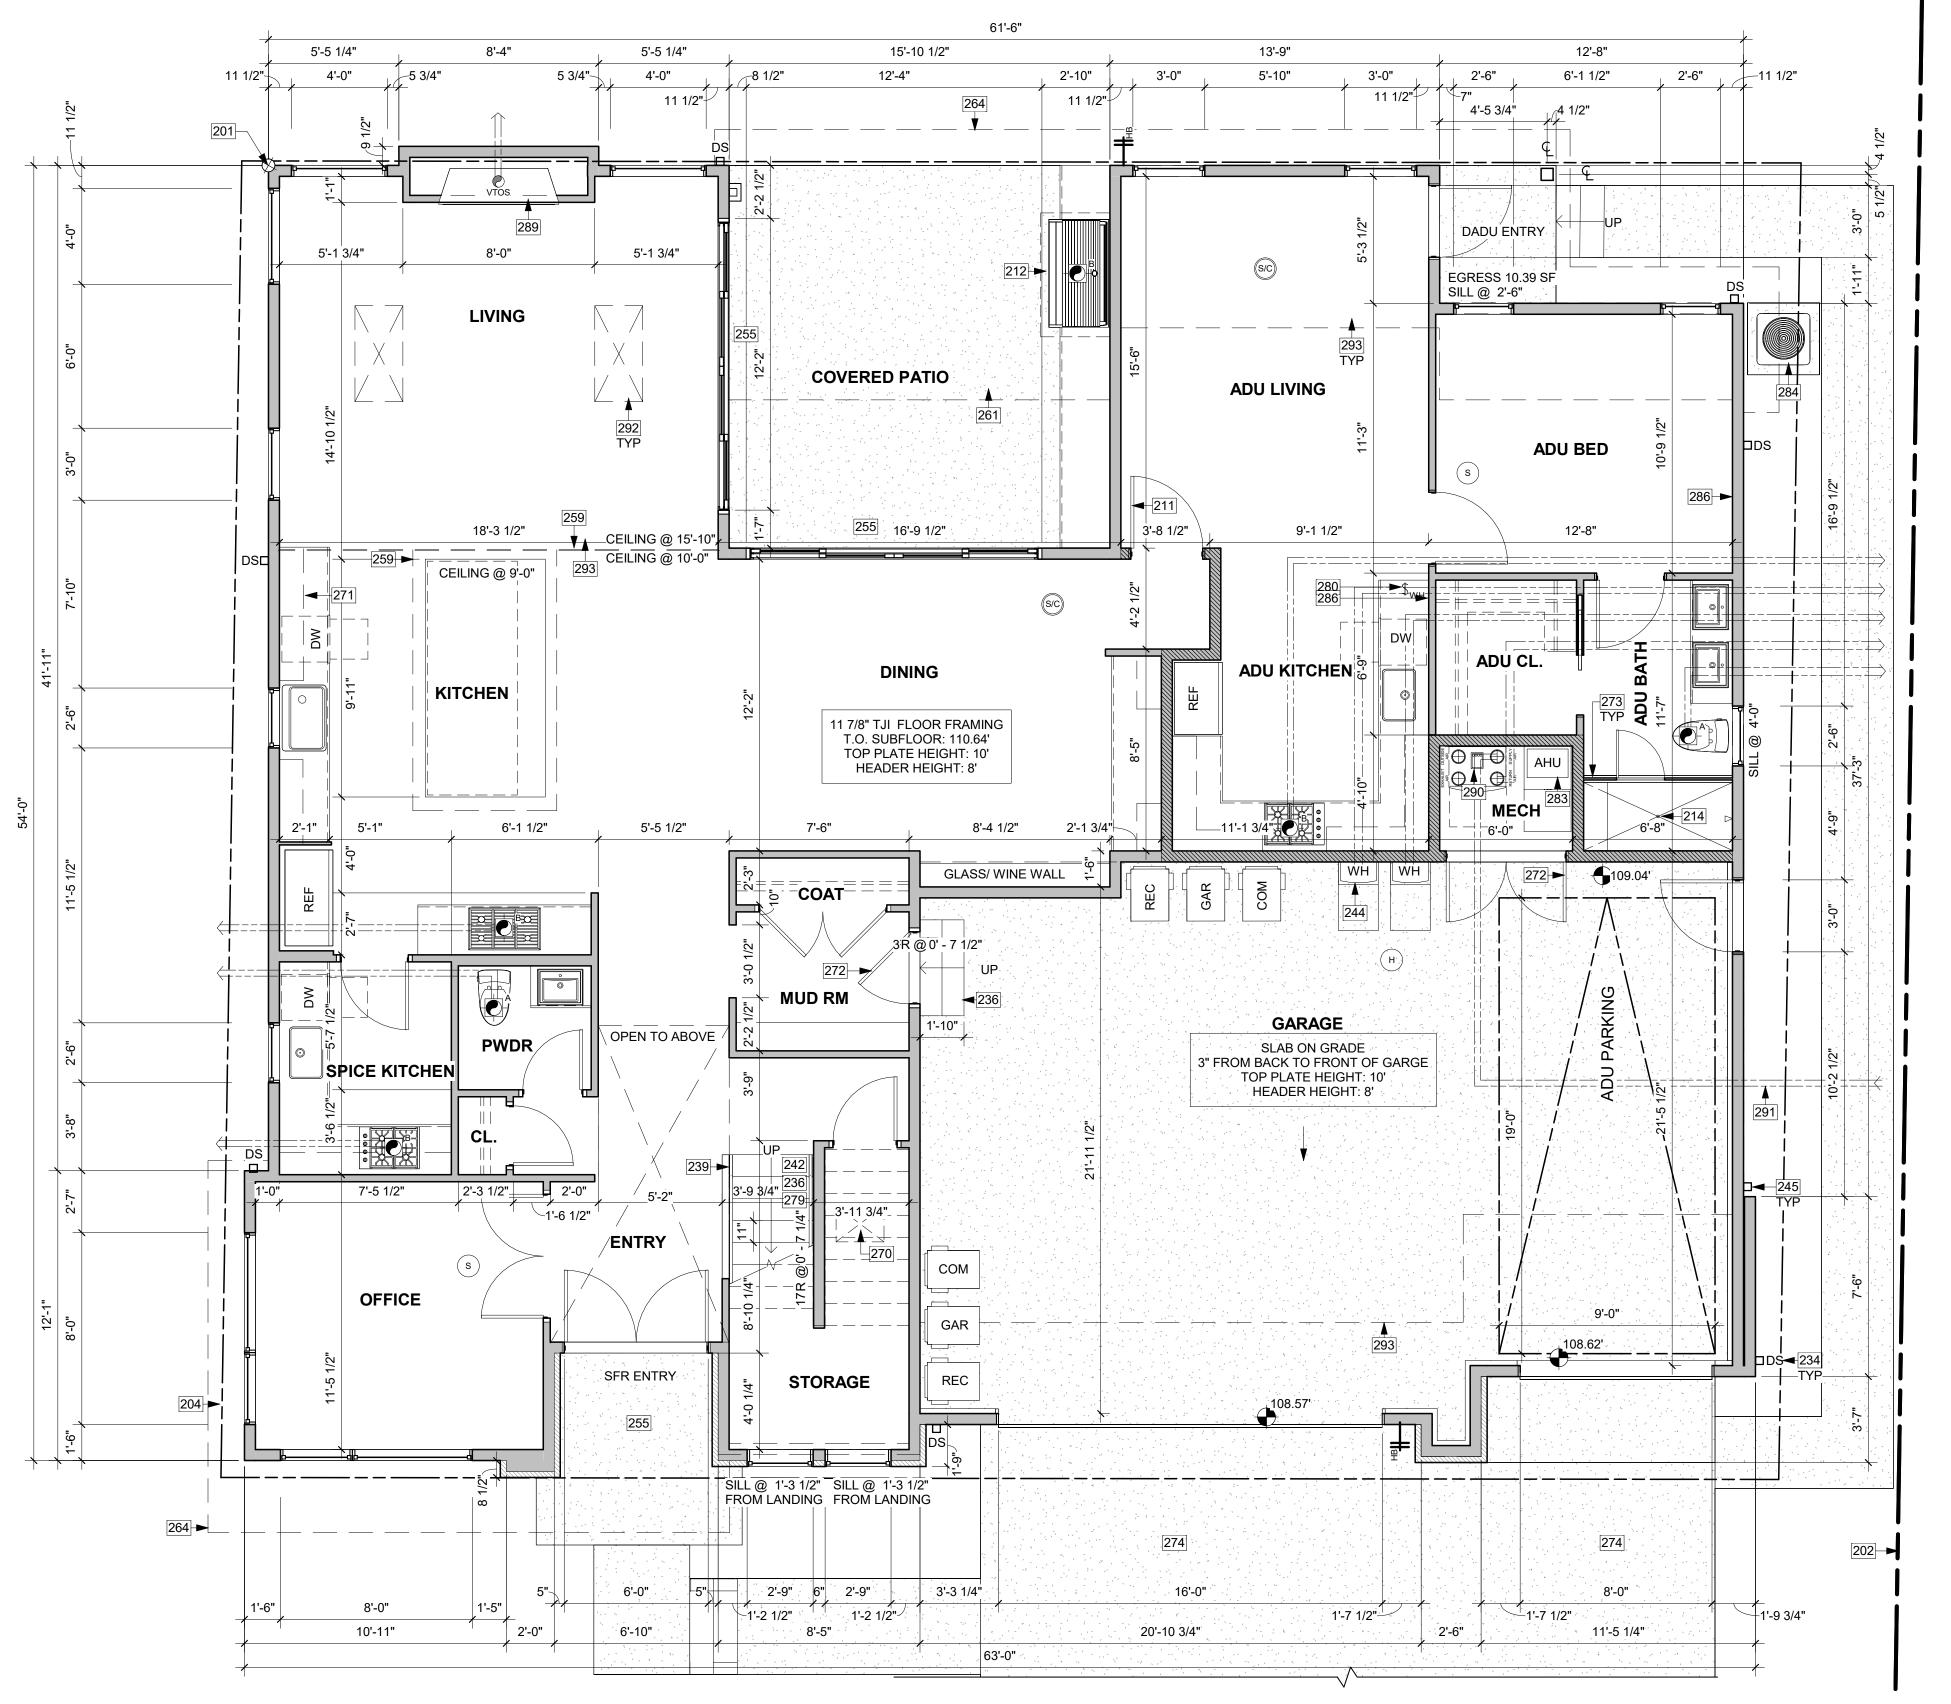DATE: 7/26/2023



1ST FLOOR PLAN 1/4" = 1'-0" 1

HOUSE VENTILATION - SFR

2018 IRC - PROVIDE WHOLE HOUSE VENTILATION PER M1505.4, INTERMITTENT WHOLE HOUSE VENTILATION USING EXHAUST FAN PER 1505.4.3 AND TABLE 1505.4.3(1) & (2); PROVIDE CONTROLS PER 1505.4.2. COMPLY WITH WSEC R403.

SYMBOL	LOCATION	MINIMUM FAN REQUIREMENTS	
-A	BATH & POWDER	MIN. 50 CFM (INTERMITTENT) @ 0.25" WG (TABLE M1505.4.4)	
- B	KITCHEN	MIN. 100 CFM (INTERMITTENT) @ 0.25" WG (TABLE M1505.4.4) RANGE HOOD OR DOWN DRAFT EXHAUST FAN RATED AT MIN. 100 CFM AT 0.10" WG MAY BE USED FOR EXHAUST FAN REQUIREMENT. IF OVER 400 CFM, MAKEUP AIR IS REQUIRED IN THE SAME ROOM PER M1503.6.	
c	LAUNDRY ROOM	MIN. 160 CFM (INTERMITTENT) @ 0.25" WG - TO FUNCTION AND BE LABELED AS WHOLE HOUSE FAN (4 BEDROOMS 3,501<4,000 SF) TO OPERATE 50% OF TIME IN EACH 4-HOUR SEGMENT. VENTILATION REQUIREMENTS TO BE MET WITH A HRV WITH A MINIMUM SENSIBLE HEAT RECOVERY EFFICIENCY OF .65 PER WSEC ENERGY CREDIT 2.2	
** MAKEUP AIR IS NOT REQUIRED IF ALL GAS APPLIANCES IN THE HOUSE HAVE A DIRECT VENT OR MECHANICAL DRAFT VENT SYSTEM, PER MODIFICATION M1503.6.			

HOUSE VENTILATION - ADU

2018 IRC - PROVIDE WHOLE HOUSE VENTILATION PER M1505.4, INTERMITTENT WHOLE HOUSE VENTILATION USING EXHAUST FAN PER 1505.4.3 AND TABLE 1505.4.3(1) & (2); PROVIDE CONTROLS PER 1505.4.2. COMPLY WITH WSEC R403.

SYMBOL	LOCATION	MINIMUM FAN REQUIREMENTS
-A	BATH & POWDER	MIN. 50 CFM (INTERMITTENT) @ 0.25" WG (TABLE M1505.4.4)
B	KITCHEN	MIN. 100 CFM (INTERMITTENT) @ 0.25" WG (TABLE M1505.4.4) RANGE HOOD OR DOWN DRAFT EXHAUST FAN RATED AT MIN. 100 CFM AT 0.10" WG MAY BE USED FOR EXHAUST FAN REQUIREMENT. IF OVER 400 CFM, MAKEUP AIR IS REQUIRED IN THE SAME ROOM PER M1503.6.
C	ROOM	MIN. 60 CFM (INTERMITTENT) @ 0.25" WG - TO FUNCTION AND BE LABELED AS WHOLE HOUSE FAN (0-1 BEDROOMS 501<1,000 SF) TO OPERATE 50% OF TIME IN EACH 4-HOUR SEGMENT.

** MAKEUP AIR IS NOT REQUIRED IF ALL GAS APPLIANCES IN THE HOUSE HAVE A DIRECT VENT OR MECHANICAL DRAFT VENT SYSTEM, PER MODIFICATION M1503.6.

201	PROJECT BASE POINT.
202	EXISTING PROPERTY LINE.
204	SETBACK LINE.
211	20-MINUTE FIRE-RATED DOOR BETWEEN SINGLE-FAMILY RESIDENCE AND ACCESSORY DWELLING UNIT.
212	PROTECTIVE MATERIAL ABOVE AND AROUND APPLIANCE TO BE INSTALLE PER MANUFACTURER SPECIFICATIONS.
214	EQUAL FLOW DRAIN WATER HEAT RECOVERY UNIT TO BE INSTALLED IN SHOWER. MINIMUM EFFICIENCY OF 40%.
234	POWDER-COATED SCUPPER AND 4" SQUARE DOWNSPOUT. TIGHTLINE ALL DOWNSPOUTS TO STORMWATER SYSTEM, PER CIVIL.
236	WOOD STAIR. STAIR STRUCTURE AND CONNECTIONS TO BE A DEFERRED SUBMITTAL.
239	GUARDRAILS. FLOOR MOUNT. DEFERRED SUBMITTAL. MIN. HEIGHT 36-INC PER IRC R312.1.2. REQUIRED GUARDS SHALL NOT HAVE OPENINGS FROM WALKING SURFACE TO THE REQUIRED GUARD HEIGHT WHICH ALLOW PASSAGE OF A SPHERE 4" IN DIAMETER, PER IRC R312.1.3 EXCEPTIONS: 1 THE TRIANGULAR OPENINGS AT THE OPEN SIDE OF STAIR, FORMED BY THE RISER, TREAT AND BOTTOM RAIL OF A GUARD, SHALL NOT ALLOW PASSAGE OF A SPHERE OF 6" IN DIAMETER. 2) GUARDS ON THE OPEN SIDE OF STAIR SHALL NOT HAVE OPENINGS WHICH ALLOW PASSAGE OF A SPHERE OF 4-IN DIAMETER. CONNECTIONS PER TYPICAL STRUCTURAL GUARDRAIL DET.
242	HANDRAIL PER IRC 311.7.8, WALL MOUNTED.
244	ENERGY STAR RATED ON DEMAND WATER HEATER PER WSEC TABLE 406. OPTION 5.3: MIN. EF= 0.91. DIRECT VENT TO OUTSIDE THROUGH WALL OR ROOF PER MANUFACTURER'S REQUIREMENTS. THE COMBUSTION AIR TO PROVIDED BY INFILTRATION OF FRESH AIR WITH A FRESH AIR VENT. ONE EACH DWELING UNIT.
245	POWDER-COATED 5" SQUARE GUTTER AND 4" SQUARE DOWNSPOUT. TIGHTLINE ALL DOWNSPOUTS TO STORMWATER SYSTEM, PER CIVIL.
255	LANDINGS OR FINISHED FLOORS AT REQUIRED EGRESS DOORS SHALL NO BE MORE THAN 1-1/2" LOWER THAN THE TOP OF THE THRESHOLD.
259	LINE OF CEILING CHANGE ABOVE.
261	LINE OF EXTERIOR WALL ABOVE. FILL FLOOR CAVITY OVER NON-CONDITIONED SPACES WITH BATT INSULATION. MINIMUM R-38.
264	LINE OF ROOF ABOVE.
270	CRAWL SPACE ACCESS IN FLOOR, PER IRC R408.4. 18"x24" MIN OPENING V R-38 INSULATION.
271	LINE OF UPPER CABINETS.
272	20 MINUTE FIRE-RATED DOOR WITH SELF CLOSER. INSULATED.
273	TEMPERED GLAZING IN SHOWER STALL. DOOR TO SWING OUTWARD.
274 279	DRIVEWAY SLOPE PER CIVIL. PROVIDE ILLUMINATION PER IRC R303.7: INTERIOR STAIRWAYS SHALL BE PROVIDED WITH AN ARTIFICIAL LIGHT SOURCE TO ILLUMINATE THE LANDI AND TREADS. THE LIGHT SOURCE SHALL BE CAPABLE OF ILLUMINATION LEVELS NOT LESS THAN 1 FOOT-CANDLE (11 LUX) AS MEASURED AT THE CENTER OF TREADS AND LANDINGS.
280	WHOLE HOUSE FAN CONTROL (WHFC) PER IRC 2018 1504.2 SHALL BE PROVIDED WITH CONTROLS THAT ENABLE MANUAL OVERRIDE. MUST OPERATE AT LEAST 50% OF TIME IN EACH 4 HOUR SEGMENT PER IRC TAB M1505.4.3(1) & (2).
283	HIGH EFFICIENCY FURNACE (92% AFUE) DIRECT VENT TO OUTSIDE. COMBUSTION & FRESH AIR TO BE PROVIDED THROUGH WALL.
284	EXTERIOR PORTION OF AIR SOURCE HEAT PUMP WITH MINIMUM HSPF OF TO SERVE BOTH SFR AND ADU WITH ZONAL CONTROL. PROVIDE MINIMUM CLEARANCES AROUND UNIT PER MANUFACTURER'S REQUIREMENTS.
286	ZONAL CONTROL FOR SHARED HVAC UNIT, SFR MAX 62448 BTU/HR, ADU N 9,709 BTU/HR.
289	GAS FIREPLACE: DIRECT VENT THROUGH THE WALL PER MANUFACTUREF REQUIREMENTS. MINIMUM FRAMING CLEARANCES PER OWNER'S SELECT UNIT, PER IRC R1004.2. FACTORY-BUILT FIREPLACES SHALL BE LISTED, LABELED AND INSTALLED WITH THE CONDITIONS OF THE LISTING, AND IN ACCORDANCE WITH UL 127. FACTORY-BUILT HEARTH EXTENSIONS FOR APPROVED FACTORY-BUILT FIREPLACES SHALL BE INSTALLED IN ACCORDANCE WITH THE LISTING OF THE FIREPLACE. THE HEARTH EXTENSION SHALL BE READILY DISTINGUISHABLE FROM THE SURROUNDI
290	FLOOR AREA. HEAT RECOVERY VENTILATOR (HRV) PROVIDED TO SERVE BOTH SFR AND ADJUMITH ZONAL CONTROL ZEHNDER COMEONIR 550 VENTILATION LINIT

ADU WITH ZONAL CONTROL. ZEHNDÉR COMFOAIR 550 VENTILATION UNIT. EXTRACT STALE AIR FROM THE KITCHEN AND BATHROOMS AND SUPPLIES FRESH AIR TO BEDROOMS AND LIVING SPACES. INSTALLATION REQUIREMENTS PER MANUFACTURE.

HRV INTAKE AND EXHAUST DUCTS.

SKYLIGHT ABOVE.

LINE OF BUILDING ABOVE

RATED CONSTRUCTION LEGEND

1-HOUR RATED WALL CONSTRUCTION

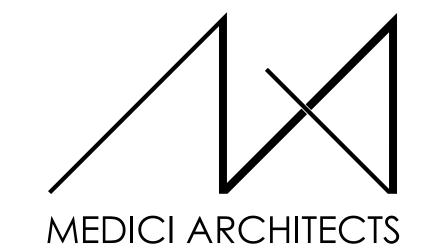
1-HOUR RATED FLOOR / ROOF CONSTRUCTION

FLOOR PLAN NOTES

- CONTRACTOR SHALL VERIFY ALL NOTES, DIMENSIONS & CONDITIONS PRIOR TO CONSTRUCTION.
- SEE STRUCTURAL DRAWINGS FOR ALL POSTS, BEAMS AND HEADERS.
- PROVIDE SOLID BLOCKING OVER SUPPORTS. PROVIDE FIRE BLOCKING @ ALL PLUMBING PENETRATIONS. WINDOWS & DOORS ARE SHOWN & NOTED AS NOMINAL SIZES.
- DOOR JAMB 4.5" FROM CORNER TYP., U.N.O. SEE SHEETS A0.3, A4.0 & A4.1 FOR WINDOW & DOOR HEADER HEIGHTS
- ABOVE FINISHED FLOOR.
- ALL WOOD IN CONTACT WITH CONCRETE TO BE PRESSURE TREATED. EXTERIOR WALLS TO BE 2x6 STUDS @ 16" O.C., U.N.O.
- INSTALL SIMPSON CONC. TO WOOD HOLDOWNS PER STRUCTURAL
- DRAWINGS, ALSO SEE MANUFACTURER'S SPECS. SMOKE & CARBON MONOXIDE DETECTORS: • SHALL BE 110V INTERCONNECTED W/ BATTERY BACKUP. • SHALL SOUND AN ALARM AUDIBLE IN ALL SLEEPING ROOMS. • SHALL BE INSTALLED ON EACH FLOOR AND IN ALL BEDROOMS.
- SHALL BE INSTALLED IN EACH LOCATION WHERE THERE IS A CEILING CHANGE OF GREATER THAN 24" LIMITING DEVICE FOR TUBS TO PROVIDE MAX. 120°F HOT WATER
- TEMPERATURE. FOOTINGS SHALL BEAR ON SOLID UNDISTURBED EARTH (CONTROLLED, COMPACTED STRUCTURAL FILL OR BOTH). DEPTH OF FOOTINGS TO BE DETERMINED BY STRUCTURAL ENGINEER. FOUNDATION EXCAVATION, BACKFILL AND COMPACTION SHALL CONFORM TO SPECIFICATION REQUIREMENTS. THIS CONSTRUCTION WORK, INCLUDING DRAINAGE, SHORING AND SUCH OTHER RELATED WORK AS REQUIRED, SHALL BE CONDUCTED BY THE CONTRACTOR. STOP WORK IF RECOMMENDED EXCAVATION CUT OR BEARING SOIL CHANGES OCCUR IN EITHER HORIZONTAL OR VERTICAL DIRECTION AND NOTIFY IMMEDIATELY THE GEOTECHNICAL ENGINEER AND STRUCTURAL ENGINEER. AT WHICH POINT THE ENGINEERS SHALL DETERMINE CAUSE OF DISPLACEMENT AND DEVELOP AND IMPLEMENT REMEDIAL MEASURES.

SYMBOL LEGEND


SEE GENERAL NOTES SHEET A0.0 FOR COMPLETE SYMBOL INDEX.



11711 SE 8TH STREET BELLEVUE, WA 98005

TEL: (425) 453-9298

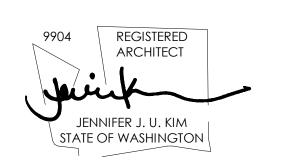REGISTRATION:



200 W. RIVER ST.

KETCHUM, ID 83340

TEL: (208) 726-0194

SUITE 301

INTAKE DATE:	07-26-2	
REVISIONS:	DATE:	

PROJECT / CLIENT:

LYNNWOOD HOUSE 2

TRIAD HOMES

PROJECT ADDRESS: 3521 169TH AVE SW LYNNWOOD, WA 98037

DRAWING NAME:

1ST FLOOR PLAN

DRAWN BY: KKH CHECKED By: JK


PHASE:

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APPROVED FOR CONSTRUCTION:

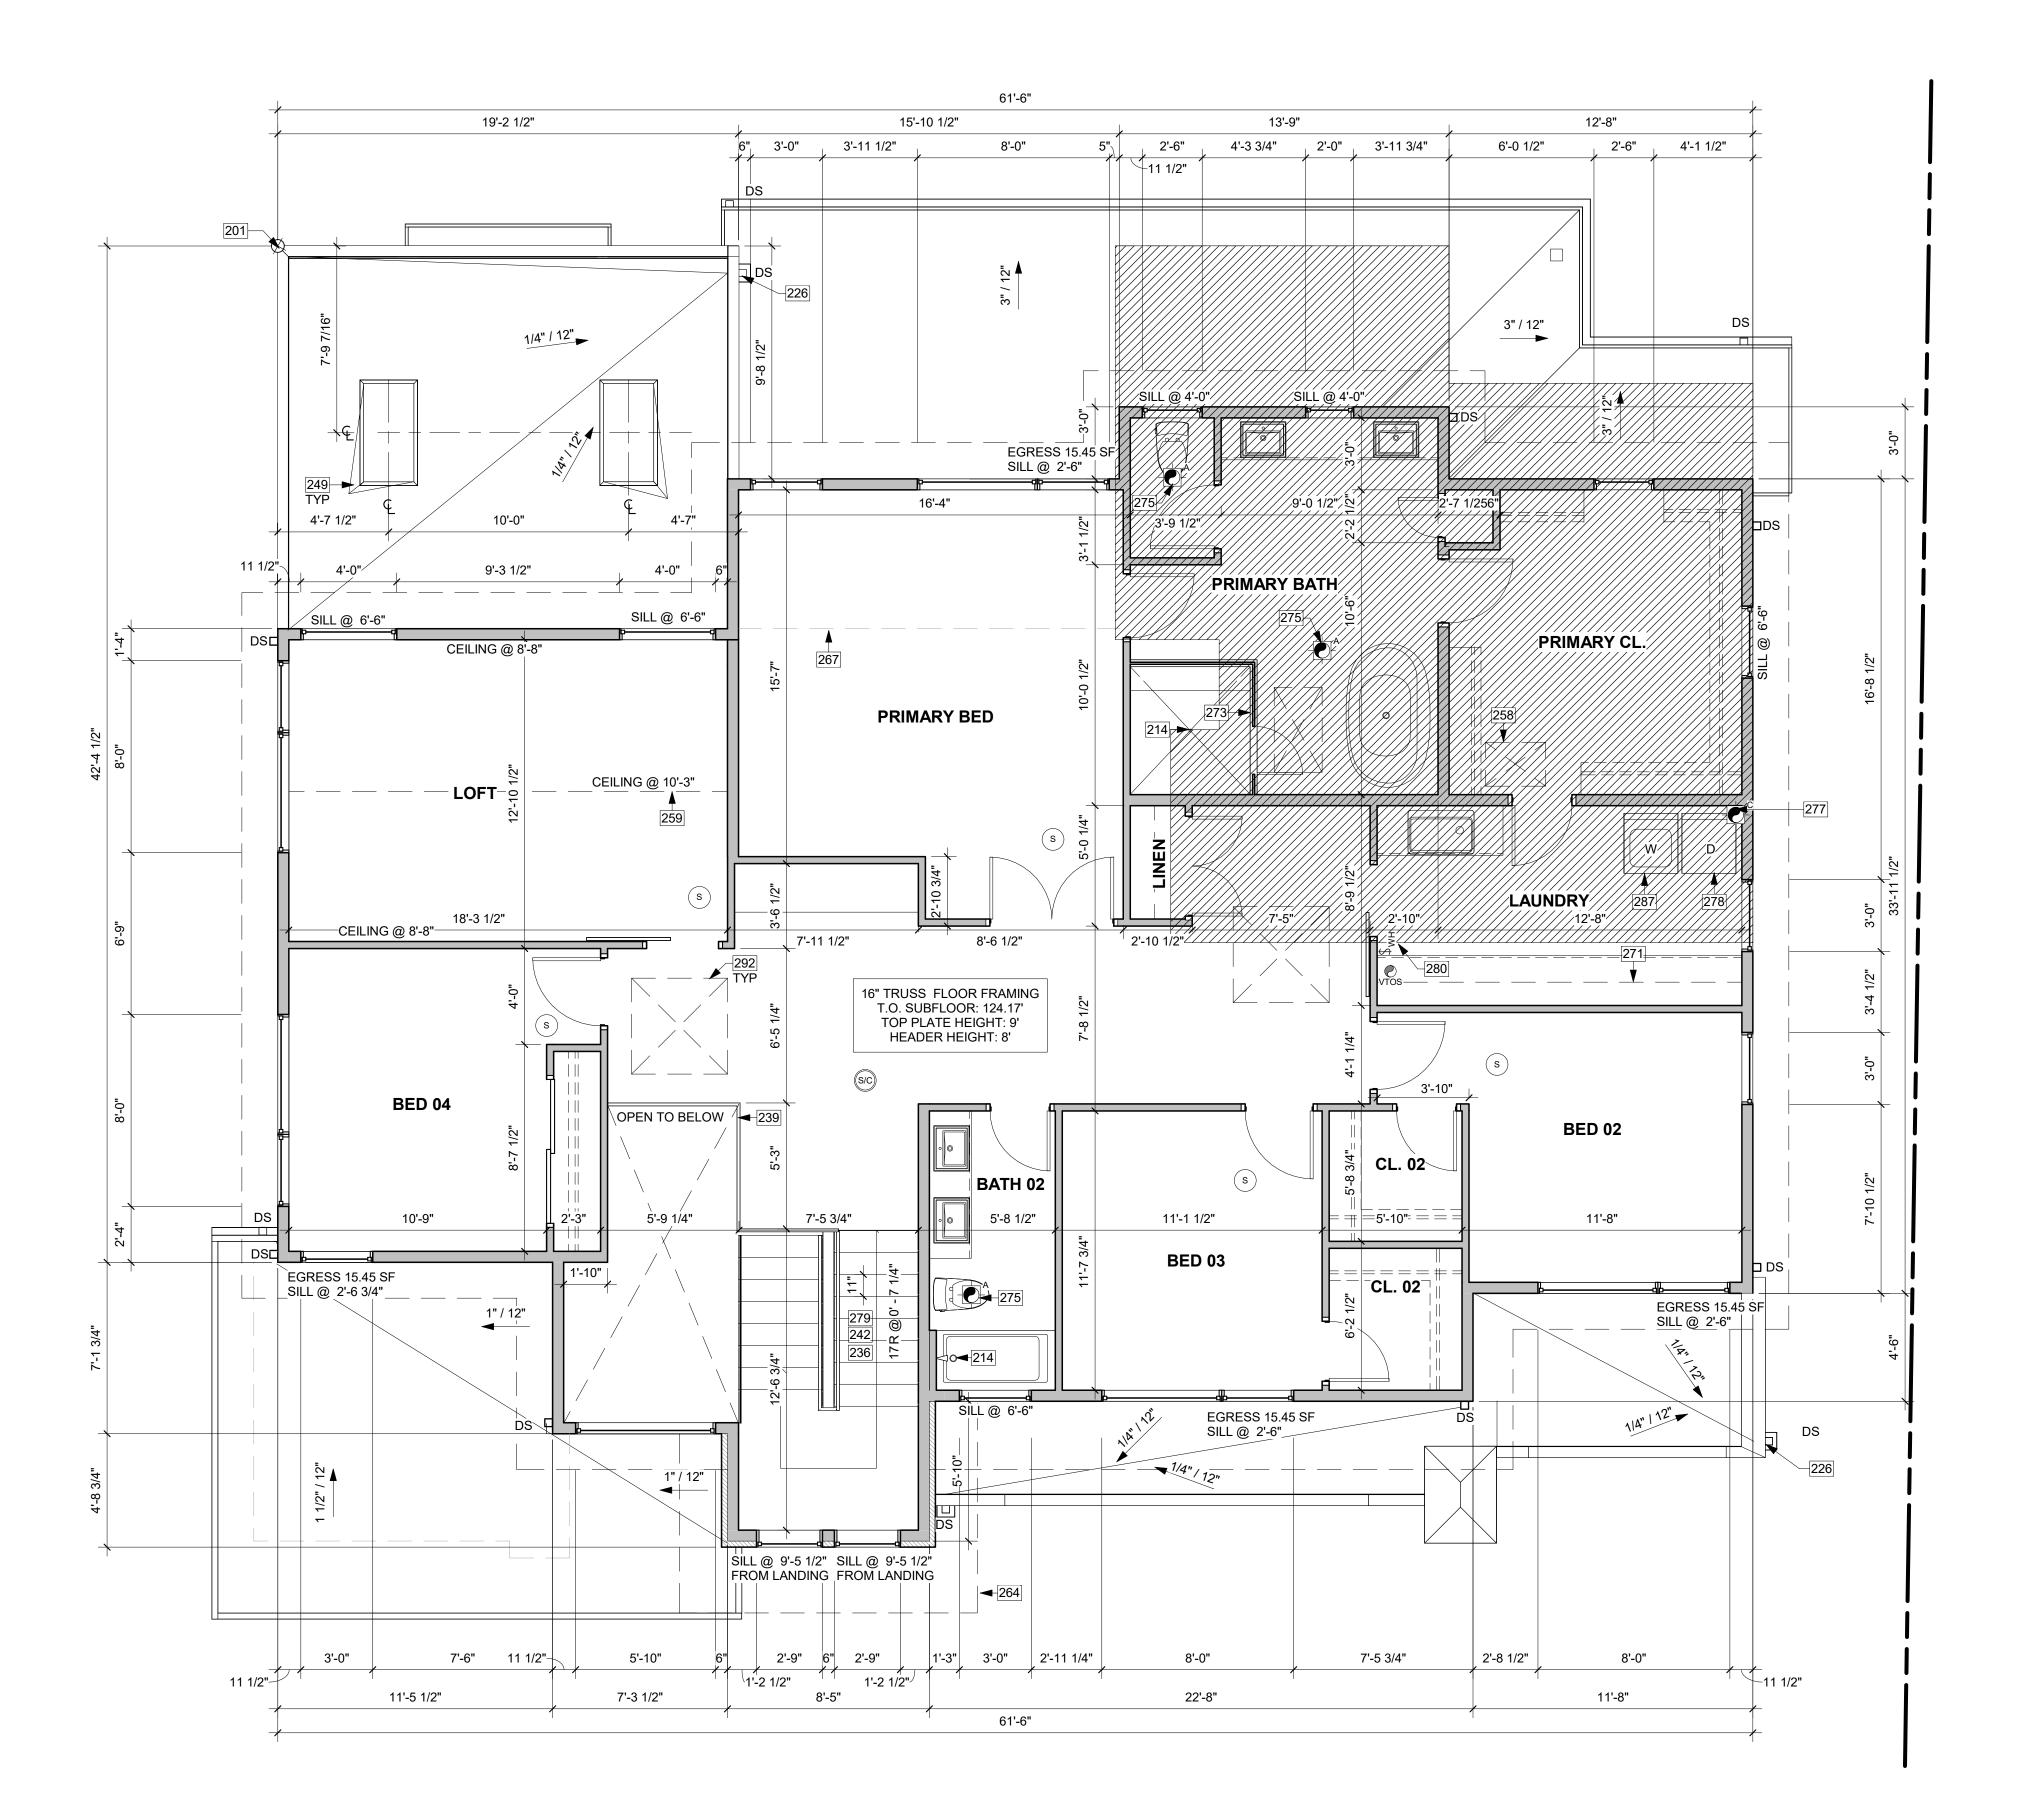PROJECT No.: A21 069 DATE: 7/26/2023





HOUSE VENTILATION - SFR

2018 IRC - PROVIDE WHOLE HOUSE VENTILATION PER M1505.4, INTERMITTENT WHOLE HOUSE VENTILATION USING EXHAUST FAN PER 1505.4.3 AND TABLE 1505.4.3(1) & (2); PROVIDE CONTROLS PER 1505.4.2. COMPLY WITH WSEC R403.

- ()	- (),	
'MBOL	LOCATION	MINIMUM FAN REQUIREMENTS
A A	BATH & POWDER	MIN. 50 CFM (INTERMITTENT) @ 0.25" WG (TABLE M1509
B	KITCHEN	MIN. 100 CFM (INTERMITTENT) @ 0.25" WG (TABLE M1505.4.4) RANGE HOOD OR DOWN DRAFT EXHAUST FRATED AT MIN. 100 CFM AT 0.10" WG MAY BE USED FOI EXHAUST FAN REQUIREMENT. IF OVER 400 CFM, MAKE AIR IS REQUIRED IN THE SAME ROOM PER M1503.6.
c	LAUNDRY ROOM	MIN. 160 CFM (INTERMITTENT) @ 0.25" WG - TO FUNCTI AND BE LABELED AS WHOLE HOUSE FAN (4 BEDROOM 3,501<4,000 SF) TO OPERATE 50% OF TIME IN EACH 4-H SEGMENT. VENTILATION REQUIREMENTS TO BE MET A HRV WITH A MINIMUM SENSIBLE HEAT RECOVERY EFFICIENCY OF .65 PER WSEC ENERGY CREDIT 2.2

** MAKEUP AIR IS NOT REQUIRED IF ALL GAS APPLIANCES IN THE HOUSE HAVE A DIRECT VENT OR MECHANICAL DRAFT VENT SYSTEM, PER MODIFICATION M1503.6. SYMBOL LEGEND

DEVELOP AND IMPLEMENT REMEDIAL MEASURES.

RATED CONSTRUCTION LEGEND

CONTRACTOR SHALL VERIFY ALL NOTES, DIMENSIONS & CONDITIONS

SEE STRUCTURAL DRAWINGS FOR ALL POSTS, BEAMS AND HEADERS.

SEE SHEETS A0.3, A4.0 & A4.1 FOR WINDOW & DOOR HEADER HEIGHTS

ALL WOOD IN CONTACT WITH CONCRETE TO BE PRESSURE TREATED. EXTERIOR WALLS TO BE 2x6 STUDS @ 16" O.C., U.N.O.

• SHALL BE INSTALLED IN EACH LOCATION WHERE THERE IS A CEILING

FOOTINGS SHALL BEAR ON SOLID UNDISTURBED EARTH (CONTROLLED, COMPACTED STRUCTURAL FILL OR BOTH). DEPTH OF FOOTINGS TO BE DETERMINED BY STRUCTURAL ENGINEER. FOUNDATION EXCAVATION,

INSTALL SIMPSON CONC. TO WOOD HOLDOWNS PER STRUCTURAL

PROVIDE FIRE BLOCKING @ ALL PLUMBING PENETRATIONS.

WINDOWS & DOORS ARE SHOWN & NOTED AS NOMINAL SIZES.

1-HOUR RATED WALL CONSTRUCTION

1-HOUR RATED FLOOR / ROOF CONSTRUCTION

PROVIDE SOLID BLOCKING OVER SUPPORTS.

DOOR JAMB 4.5" FROM CORNER TYP., U.N.O.

SMOKE & CARBON MONOXIDE DETECTORS:

CHANGE OF GREATER THAN 24"

TEMPERATURE.

DRAWINGS, ALSO SEE MANUFACTURER'S SPECS.

• SHALL BE 110V INTERCONNECTED W/ BATTERY BACKUP.

• SHALL SOUND AN ALARM AUDIBLE IN ALL SLEEPING ROOMS. • SHALL BE INSTALLED ON EACH FLOOR AND IN ALL BEDROOMS.

LIMITING DEVICE FOR TUBS TO PROVIDE MAX. 120°F HOT WATER

BACKFILL AND COMPACTION SHALL CONFORM TO SPECIFICATION

REQUIREMENTS. THIS CONSTRUCTION WORK, INCLUDING DRAINAGE

THE ENGINEERS SHALL DETERMINE CAUSE OF DISPLACEMENT AND

SHORING AND SUCH OTHER RELATED WORK AS REQUIRED, SHALL BE CONDUCTED BY THE CONTRACTOR. STOP WORK IF RECOMMENDED EXCAVATION CUT OR BEARING SOIL CHANGES OCCUR IN EITHER HORIZONTAL OR VERTICAL DIRECTION AND NOTIFY IMMEDIATELY THE GEOTECHNICAL ENGINEER AND STRUCTURAL ENGINEER. AT WHICH POINT

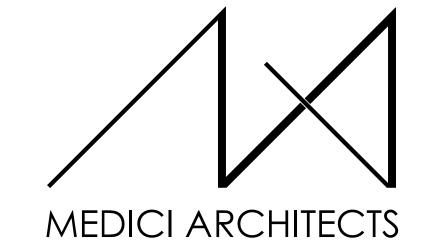
FLOOR PLAN NOTES

PRIOR TO CONSTRUCTION.

ABOVE FINISHED FLOOR.


KEY NOTES

- PROJECT BASE POINT.
- EQUAL FLOW DRAIN WATER HEAT RECOVERY UNIT TO BE INSTALLED IN SHOWER, MINIMUM EFFICIENCY OF 40%.
- THRU WALL DRAIN.
- WOOD STAIR. STAIR STRUCTURE AND CONNECTIONS TO BE A DEFERRED
- GUARDRAILS. FLOOR MOUNT. DEFERRED SUBMITTAL. MIN. HEIGHT 36-INCHES PER IRC R312.1.2. REQUIRED GUARDS SHALL NOT HAVE OPENINGS FROM THE WALKING SURFACE TO THE REQUIRED GUARD HEIGHT WHICH ALLOW PASSAGE OF A SPHERE 4" IN DIAMETER, PER IRC R312.1.3 EXCEPTIONS: 1) THE TRIANGULAR OPENINGS AT THE OPEN SIDE OF STAIR, FORMED BY THE RISER, TREAT AND BOTTOM RAIL OF A GUARD, SHALL NOT ALLOW PASSAGE OF A SPHERE OF 6" IN DIAMETER. 2) GUARDS ON THE OPEN SIDE OF STAIRS SHALL NOT HAVE OPENINGS WHICH ALLOW PASSAGE OF A SPHERE OF 4-3/8" IN DIAMETER. CONNECTIONS PER TYPICAL STRUCTURAL GUARDRAIL DETAILS.
- 242 HANDRAIL PER IRC 311.7.8, WALL MOUNTED.
- BUILT-UP RIGID INSULATION CRICKET, WITH PROTECTION BOARD OVER. SLOPE MINIMUM 1/4" PER 12".
- ATTIC ACCESS PER R807.1. ROUGH OPENING NO LESS THAN 22"x30". 30" MIN UNOBSTRUCTED HEADROOM IN ATTIC SPACE ABOVE ACCESS DOOR.
- LINE OF CEILING CHANGE ABOVE. LINE OF ROOF ABOVE.
- LINE OF EXTERIOR WALL BELOW. FILL FLOOR CAVITY OVER NON-CONDITIONED SPACES WITH BATT INSULATION. MINIMUM R-38.
- LINE OF UPPER CABINETS.
- 273 TEMPERED GLAZING IN SHOWER STALL. DOOR TO SWING OUTWARD. 275 BATHROOM FAN TO BE VENTED OUTSIDE THROUGH THE ROOF.
- 277 DRYER TO BE VENTED OUTSIDE THROUGH ROOF. 278 DRYER TO BE VENTED OUTSIDE THROUGH THE WALL. VERIFY 3'-0" MINIMUM
- CLEARANCE FROM GLAZING. PROVIDE ILLUMINATION PER IRC R303.7: INTERIOR STAIRWAYS SHALL BE PROVIDED WITH AN ARTIFICIAL LIGHT SOURCE TO ILLUMINATE THE LANDINGS AND TREADS. THE LIGHT SOURCE SHALL BE CAPABLE OF ILLUMINATION
- LEVELS NOT LESS THAN 1 FOOT-CANDLE (11 LUX) AS MEASURED AT THE CENTER OF TREADS AND LANDINGS. WHOLE HOUSE FAN CONTROL (WHFC) PER IRC 2018 1504.2 SHALL BE PROVIDED WITH CONTROLS THAT ENABLE MANUAL OVERRIDE. MUST
- OPERATE AT LEAST 50% OF TIME IN EACH 4 HOUR SEGMENT PER IRC TABLE M1505.4.3(1) & (2). WASHING AND DRYING MACHINES. PROVIDE FLOOR SAVER PAN WITH A TRAP SEAL PRIMER, PER UPC 1007.1 UNDER WASHER WITH TIGHTLINE DRAIN TO SANITARY SEWER. PROVIDE DRYER BOX IN WALL FOR DRYER VENT TO
- PREVENT COMPROMISING DUCTWORK. VENT THROUGH WALL. SKYLIGHT ABOVE.



11711 SE 8TH STREET 200 W. RIVER ST. SUITE 301 SUITE 100 KETCHUM, ID 83340 BELLEVUE, WA 98005 TEL: (425) 453-9298 TEL: (208) 726-0194

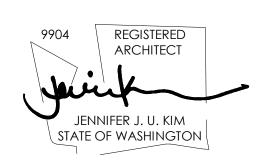REGISTRATION:



07-26-2023 **INTAKE DATE:**

REVISIONS:	DATE:	

PROJECT / CLIENT:

LYNNWOOD HOUSE 2

TRIAD HOMES

PROJECT ADDRESS: 3521 169TH AVE SW LYNNWOOD, WA 98037

DRAWING NAME:

2ND FLOOR PLAN

DRAWN BY: KKH CHECKED By: JK

PHASE:

ADU LAND USE PERMTI

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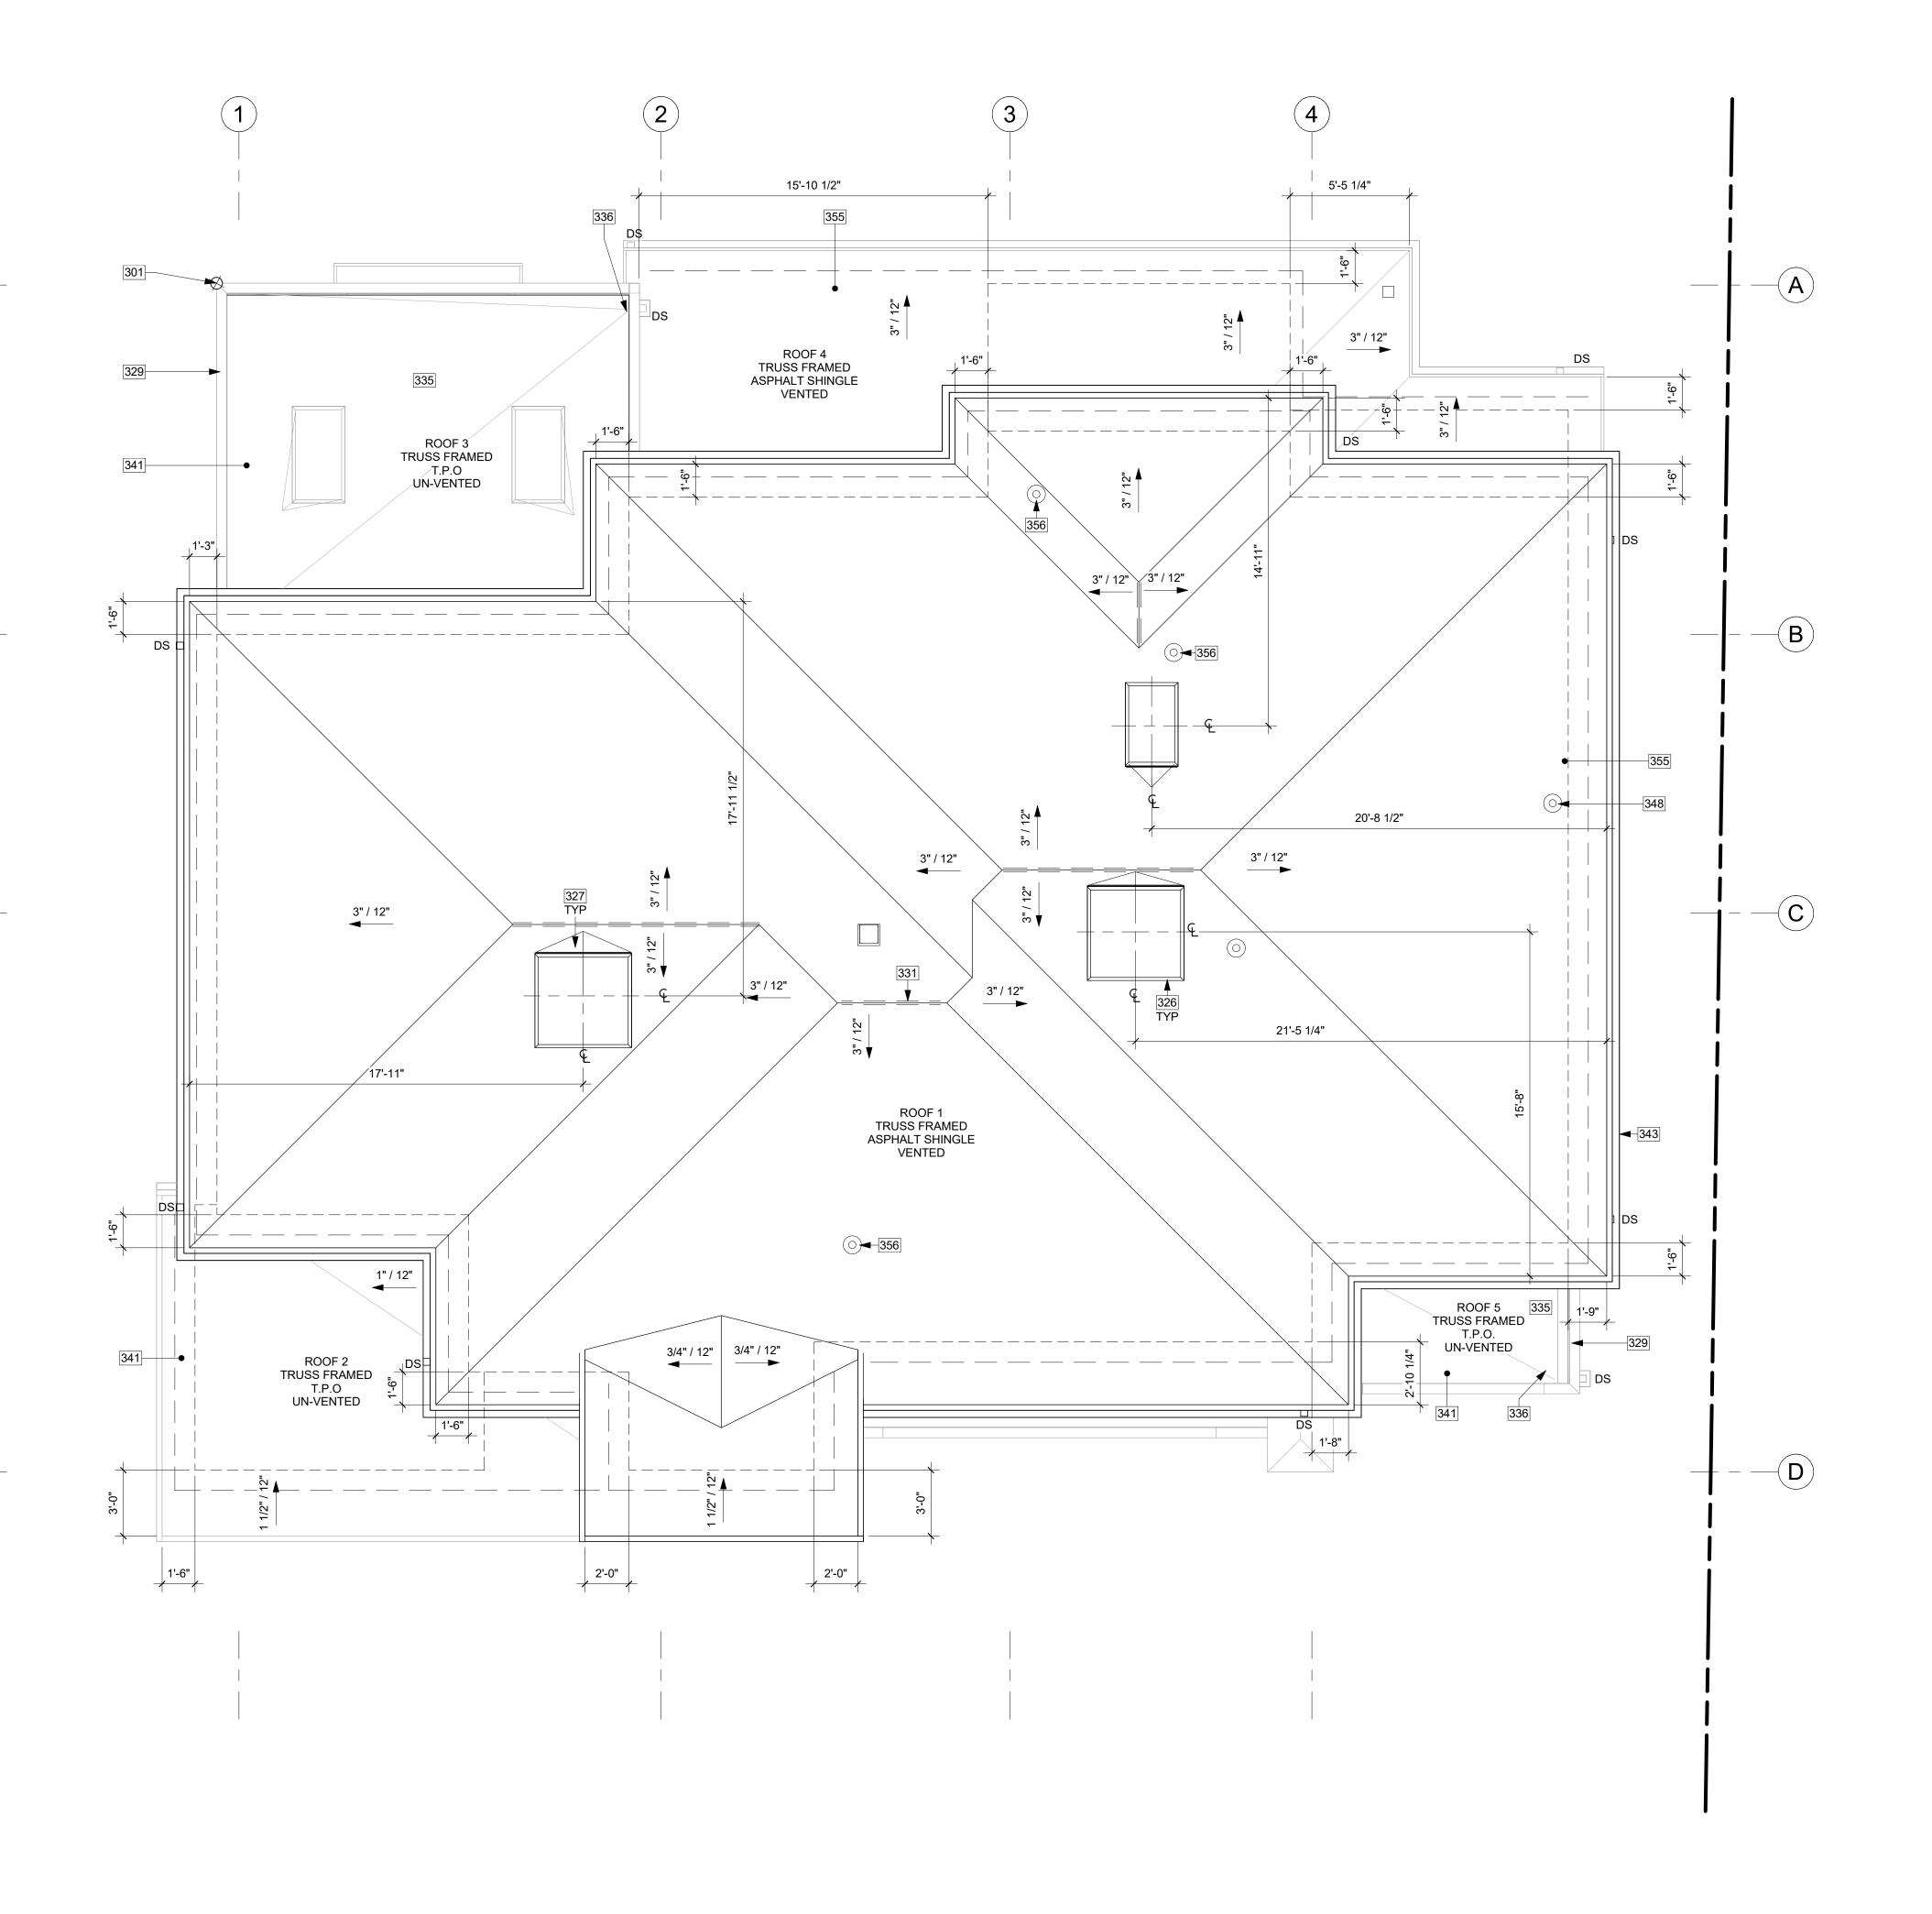
APPROVED FOR CONSTRUCTION:

PROJECT No.: A21 069

DATE: 7/26/2023

PLOT SCALE: 1:1

SEE GENERAL NOTES SHEET A0.0 FOR COMPLETE SYMBOL INDEX.






ROOF PLAN 1/4" = 1'-0" 1

KEY NOTES


301	PROJECT BASE POINT.
326	SKYLIGHT PER SCHEDULE, TYP. INSTALL WITH CURB AND FLASHING PER STRUCTURAL AND MANUFACTURER.
327	BUILT-UP RIGID INSULATION CRICKET, WITH PROTECTION BOARD OVER. SLOPE MINIMUM 1/4" PER 12".
329	VENTED PARAPET WITH 20 GA. SLOPED POWDER-COATED METAL CAP FLASHING.
331	DASHED LINE INDICATES CONTINUOUS RIDGE VENT PROVIDING 18 SQUARE INCHES OF VENTILATION PER LINEAR FOOT. SEE ROOF VENT TABLE
335	ROOF: UN-VENTED CAVITY. PROVIDE MINIMUM 7-INCHES ICYNENE PROSEAL (MD-C-200 v3) CLOSED-CELL WATER-BASED SPRAY FOAM INSULATION. R-7.1 PER INCH. MINIMUM TOTAL R-49. A COPY OF THE ICC-ES REPORT FOR THE INSULATION PRODUCT MUST BE PROVIDED ON SITE FOR THE FIELD INSPECTOR. THE APPLIED SPRAY FOAM MUST BE INSTALLED IN ACCORDANCE WITH THE MANUFACTURER'S INSTRUCTIONS BY A CERTIFIED INSTALLER.
336	PROVIDE SLOPE FOR FREE DRAINAGE PATH TO SCUPPER, MINIMUM 1/4":12" @ VALLEY.
341	TPO ROOFING INSTALLED PER MANUFACTURER. PER R905.2.2, DOUBLE LAYER OF UNDERLAYMENT REQUIRED IF ROOF PITCH IS SHALLOWER THAN 4:12.
343	POWDER-COATED 5" SQUARE GUTTER AND 4" SQUARE DOWNSPOUT. TIGHTLINE ALL DOWNSPOUTS TO STORMWATER SYSTEM, PER CIVIL.
348	DRYER TO BE VENT THROUGH ROOF.
355	ASPHALT SHINGLE ROOF. ROOFING SYSTEM PER IRC R905.2.
356	BATHROOM FAN VENT THROUGH ROOF.

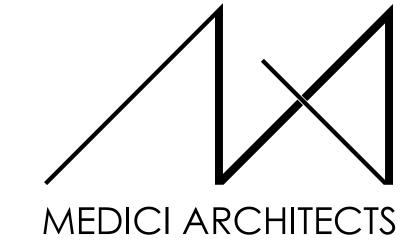

11711 SE 8TH STREET SUITE 100 BELLEVUE, WA 98005 TEL: (425) 453-9298

200 W. RIVER ST. SUITE 301 KETCHUM, ID 83340 TEL: (208) 726-0194

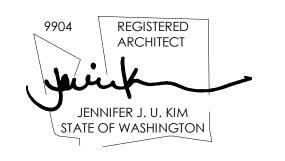REGISTRATION:



INTAKE DATE:	07-26-2023
REVISIONS:	DATE:

PROJECT / CLIENT:

LYNNWOOD HOUSE 2

TRIAD HOMES

PROJECT ADDRESS: 3521 169TH AVE SW LYNNWOOD, WA 98037

DRAWING NAME:

ROOF PLAN

DRAWN BY: KKH

CHECKED By: JK

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PHASE:

SYMBOL LEGEND

 RIDGE VENT
 EAVE VENT
BUILDING BELOW
ROOF HAT VENT

ROOF VENTILATION

(4) 2-1/2" DIA. HOLES PER 24": 9.8 SI / LF - 25%

ROOF 1

ROOF CONSTRUCTION:	PARALLEL CHORD TRUSSES	
ROOF AREA:	2,229.36 SF	
VENTILATION REQUIRED:	(2,229.36 SF x 144 SI) / 150*	= 2,140.19 SI REQUIRED
PROPOSED VENTILATION:		
(4) 2-1/2" DIA. HOLES PER 24":	9.8 SI / LF - 25%	= 7.35 SI / LF
PROVIDE:	221.63 LF EAVE VENTILATION	= 1,628.98 SI
2" WIDE RIDGE VENT:	18 SI / LF	= 18 SI / LF
PROVIDE:	27.08 LF RIDGE VENTILATION	= 487.44 SI
ROOF HAT VENT:	50 SI / VENT	= 50 SI / VENT
PROVIDE:	1 ROOF HAT VENTS	= 50 SI
TOTAL MIN. VENTILATION PRO	OVIDED = 2,166.42 SI IS GREATE	R THAN 2,140.19 REQ.
ROOF 2		
ROOF CONSTRUCTION:	PARALLEL CHORD TRUSSES	
ROOF AREA:	148.55 SF	
VENTILATION REQUIRED:	(148.55 SF x 144 SI) / 150*	= 142.61 SI REQUIRED
PROPOSED VENTILATION:		
(4) 2-1/2" DIA. HOLES PER 24":	9.8 SI / LF - 25%	= 7.35 SI / LF
(4) 2-1/2" DIA. HOLES PER 24": PROVIDE:	9.8 SI / LF - 25% 32.5 LF EAVE VENTILATION	= 7.35 SI / LF = 238.88 SI
PROVIDE:		= 238.88 SI
PROVIDE:	32.5 LF EAVE VENTILATION	= 238.88 SI
PROVIDE: TOTAL MIN. VENTILATION PRO	32.5 LF EAVE VENTILATION	= 238.88 SI
PROVIDE: TOTAL MIN. VENTILATION PRO ROOF 4	32.5 LF EAVE VENTILATION OVIDED = 238.88 SI IS GREATER	= 238.88 SI

= 7.35 SI / LF

48.5 LF EAVE VENTILATION = 356.48 SI

TOTAL MIN. VENTILATION PROVIDED = 356.48 SI IS GREATER THAN 137.19 REQ. * PER IRC R806.2, MINIMUM NET FREE VENTILATION AREA SHALL BE 1/150 OF THE AREA. AS AN ALTERNATIVE, THE NET FREE CROSS VENTILATION AREA MAY BE

REDUCED TO 1/300 WHEN BETWEEN 40-50% OF REQUIRED VENTILATION AREA IS LOCATED IN THE UPPER PORTION OF ROOF, PER IRC SECTION R806.2.2

DATE: 7/26/2023

PLOT SCALE: 1:1

PROJECT No.: A21 069



- **KEY NOTES** 424 LINE OF EXISTING GRADE 425 LINE OF PROPOSED GRADE. 431 LINE OF FOOTING BEYOND. LANDINGS OR FINISHED FLOORS AT REQUIRED EGRESS DOORS SHALL NOT BE MORE THAN 1-1/2" LOWER THAN THE TOP OF THE THRESHOLD. VINYL WINDOWS PER SCHEDULE. SAFETY GLAZING AND EGRESS WHERE LIGHTING AT ALL EXTERIOR DOORS, TYP. PROVIDE BACKING FOR ATTACHMENT. TIGHT KNOT CEDAR T&G SOFFIT WITH 4" EXPOSURE, SEAL & STAIN ALL SIDES AND ALL CUTS BEFORE INSTALLING, TYP. PROVIDE 2-INCH CONTINUOUS 465 FIBER CEMENT PANEL, RAINSCREEN, PAINTED. NOTE: ALL FIBER CEMENT PANEL DIVISIONS TO ALIGN WITH WINDOWS AS SHOWN, TYP. NOTE: PAINTABLE XOCR TAMLYN SPLINE TO MATCH PANEL COLOR, TYP. 466 | FIBER CEMENT PLANK, HORIZONTAL LAP SIDING WITH 6" EXPOSURE, PAINTED - COLOR TBD, TYP. NOTE: PAINTABLE XOCR TAMLYN SPLINE TO MATCH PANEL COLOR, TYP.
- | 468 | FIBER CEMENT PANEL INFILL, PAINTED; MATCH WINDOW COLOR 469 STONE VENEER, DRY STACK. 470 ASPHALT SHINGLE ROOF. ROOFING SYSTEM PER SRC R905.2. 4" SQUARE GUTTER OVER 2X6 OVER 2X10 STEPED FASCIA, PRIMED,
- FINGER-JOINTED CEDAR FASCIA BOARD. 2X10 OVER 2X16 STEPED PAINTED WOOD FASCIA, COLOR BLACK, WITH 20 GA. POWDER COATED METAL FLASHING WITH CONTINUOUS CLEAT. 474 2X10 PRIMED, FINGER-JOINTED CEDAR FASCIA BOARD.
- POWDER-COATED SCUPPER AND 4" SQUARE DOWNSPOUT. TIGHTLINE ALL DOWNSPOUTS TO STORMWATER SYSTEM, PER CIVIL. 476 4" SQUARE DOWNSPOUT. TIGHTLINE ALL DOWNSPOUTS TO STORMWATER
- SYSTEM. PER CIVIL. 477 20 GA., POWDER COATED METAL COPING. PROVIDE CONTINUOUS STRIP VENT
- PER DETAILS, TYP. 480 STOVE & COOKTOP HOOD VENT TERMINATION. VERIFY 3'-0" MINIMUM
- CLEARANCE FROM GLAZING. GAS FIREPLACE DIRECT VENT. VERIFY 3'-0" MINIMUM CLEARANCE FROM
- 482 EXHAUST VENT. VERIFY 3'-0" MINIMUM CLEARANCE FROM GLAZING. HOT WATER HEATER VENT TERMINATION. VERIFY 3'-0" MINIMUM CLEARANCE SKYLIGHT PER SCHEDULE, TYP. INSTALL WITH CURB AND FLASHING PER
- HRV FRESH AIR INTAKE. VERIFY 3' FROM EXHAUST AIR VENT. 493 HRV EXHAUST AIR VENT. VERIFY 3' FROM FRESH AIR INTAKE.

STRUCTURAL AND MANUFACTURER.

MEDICI ARCHITECTS

11711 SE 8TH STREET SUITE 100 BELLEVUE, WA 98005 TEL: (425) 453-9298

200 W. RIVER ST. SUITE 301 KETCHUM, ID 83340 TEL: (208) 726-0194

REGISTRATION:



INTAK	(E DATE:	07-26-2023	
REVIS	SIONS:	DATE:	
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		TYP	

PROJECT / CLIENT:

LYNNWOOD HOUSE 2

TRIAD HOMES

PROJECT ADDRESS: 3521 169TH AVE SW LYNNWOOD, WA 98037

DRAWING NAME:

ELEVATIONS

DRAWN BY: KKH CHECKED By: JK

ADU LAND USE PERMTI

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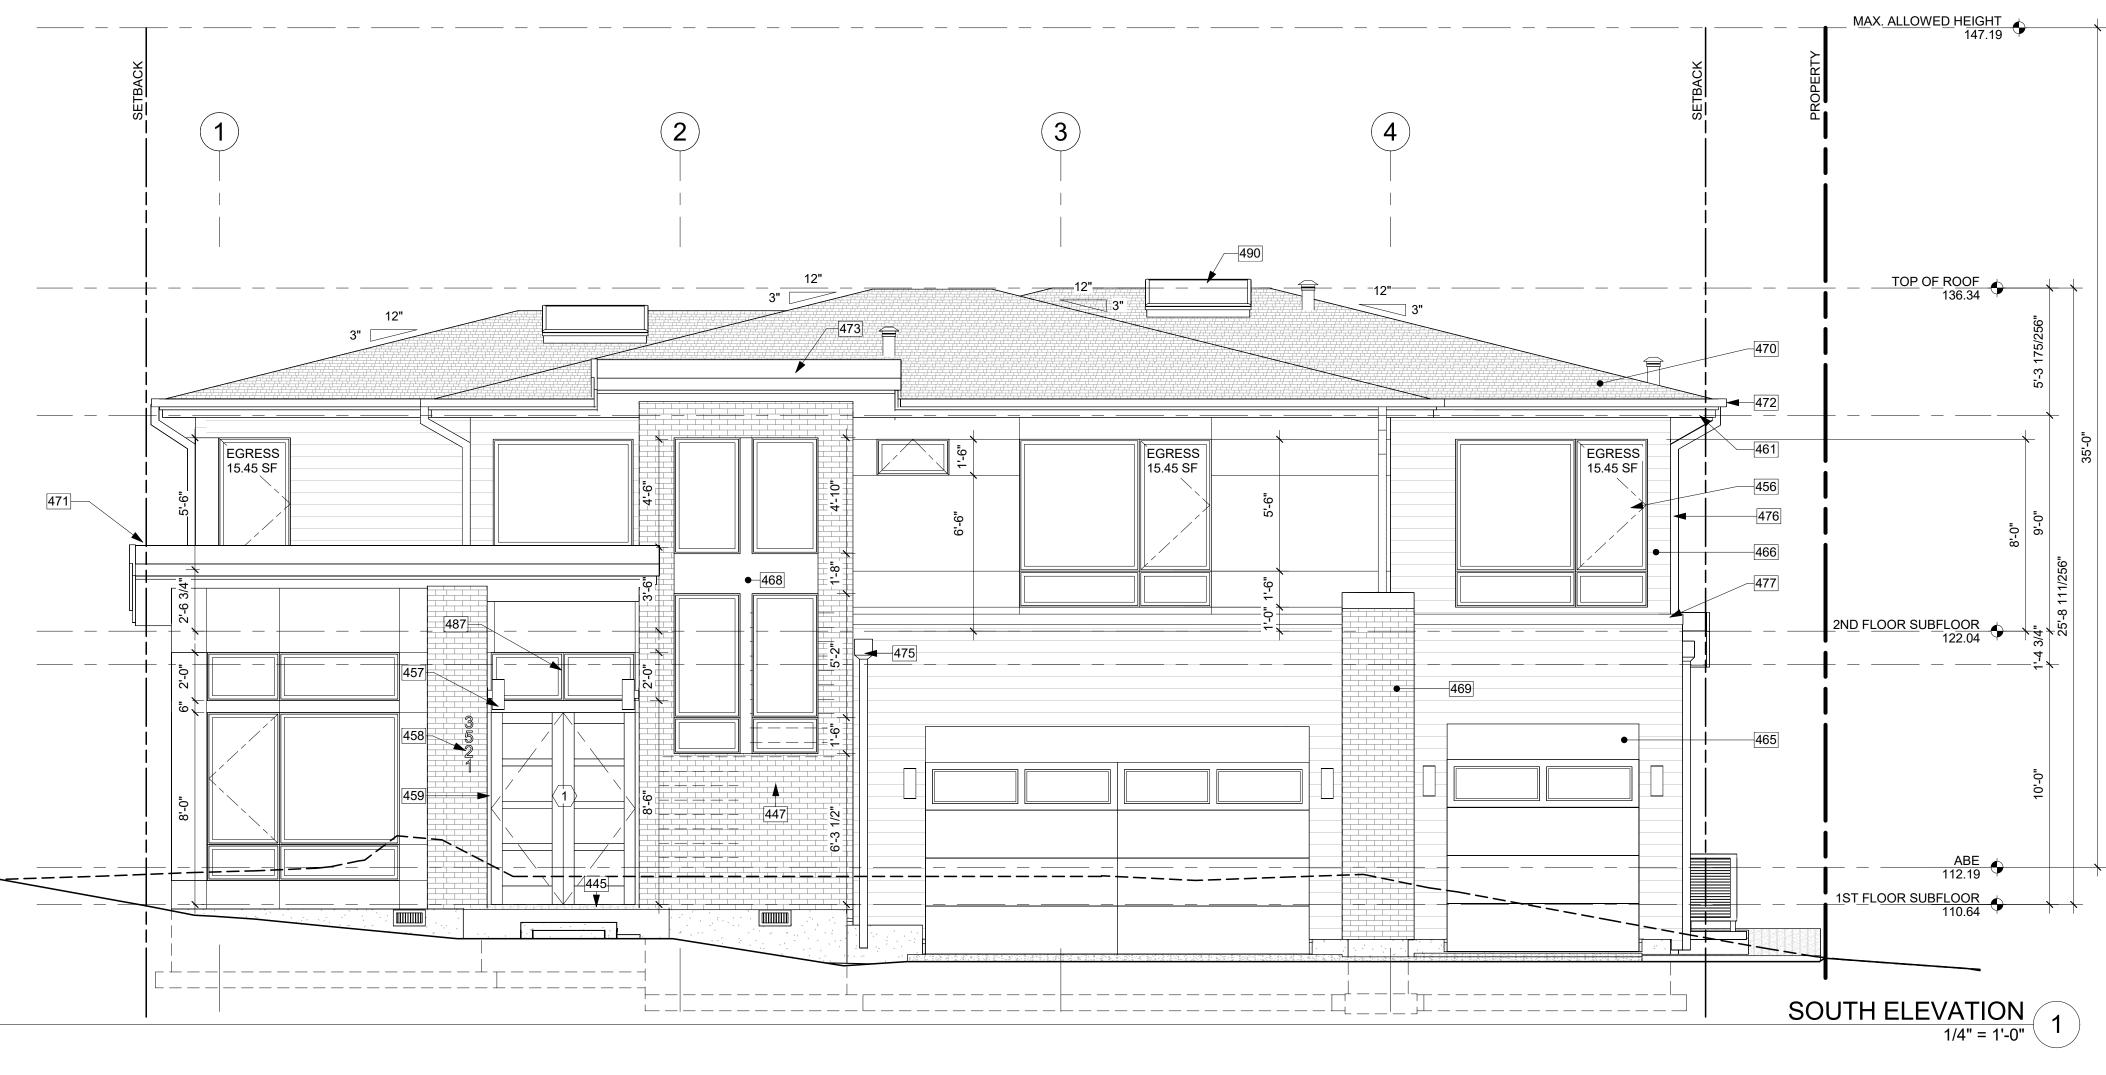
PROJECT No.: A21 069


DATE: 7/26/2023

PLOT SCALE: 1:1

ELEVATION NOTES

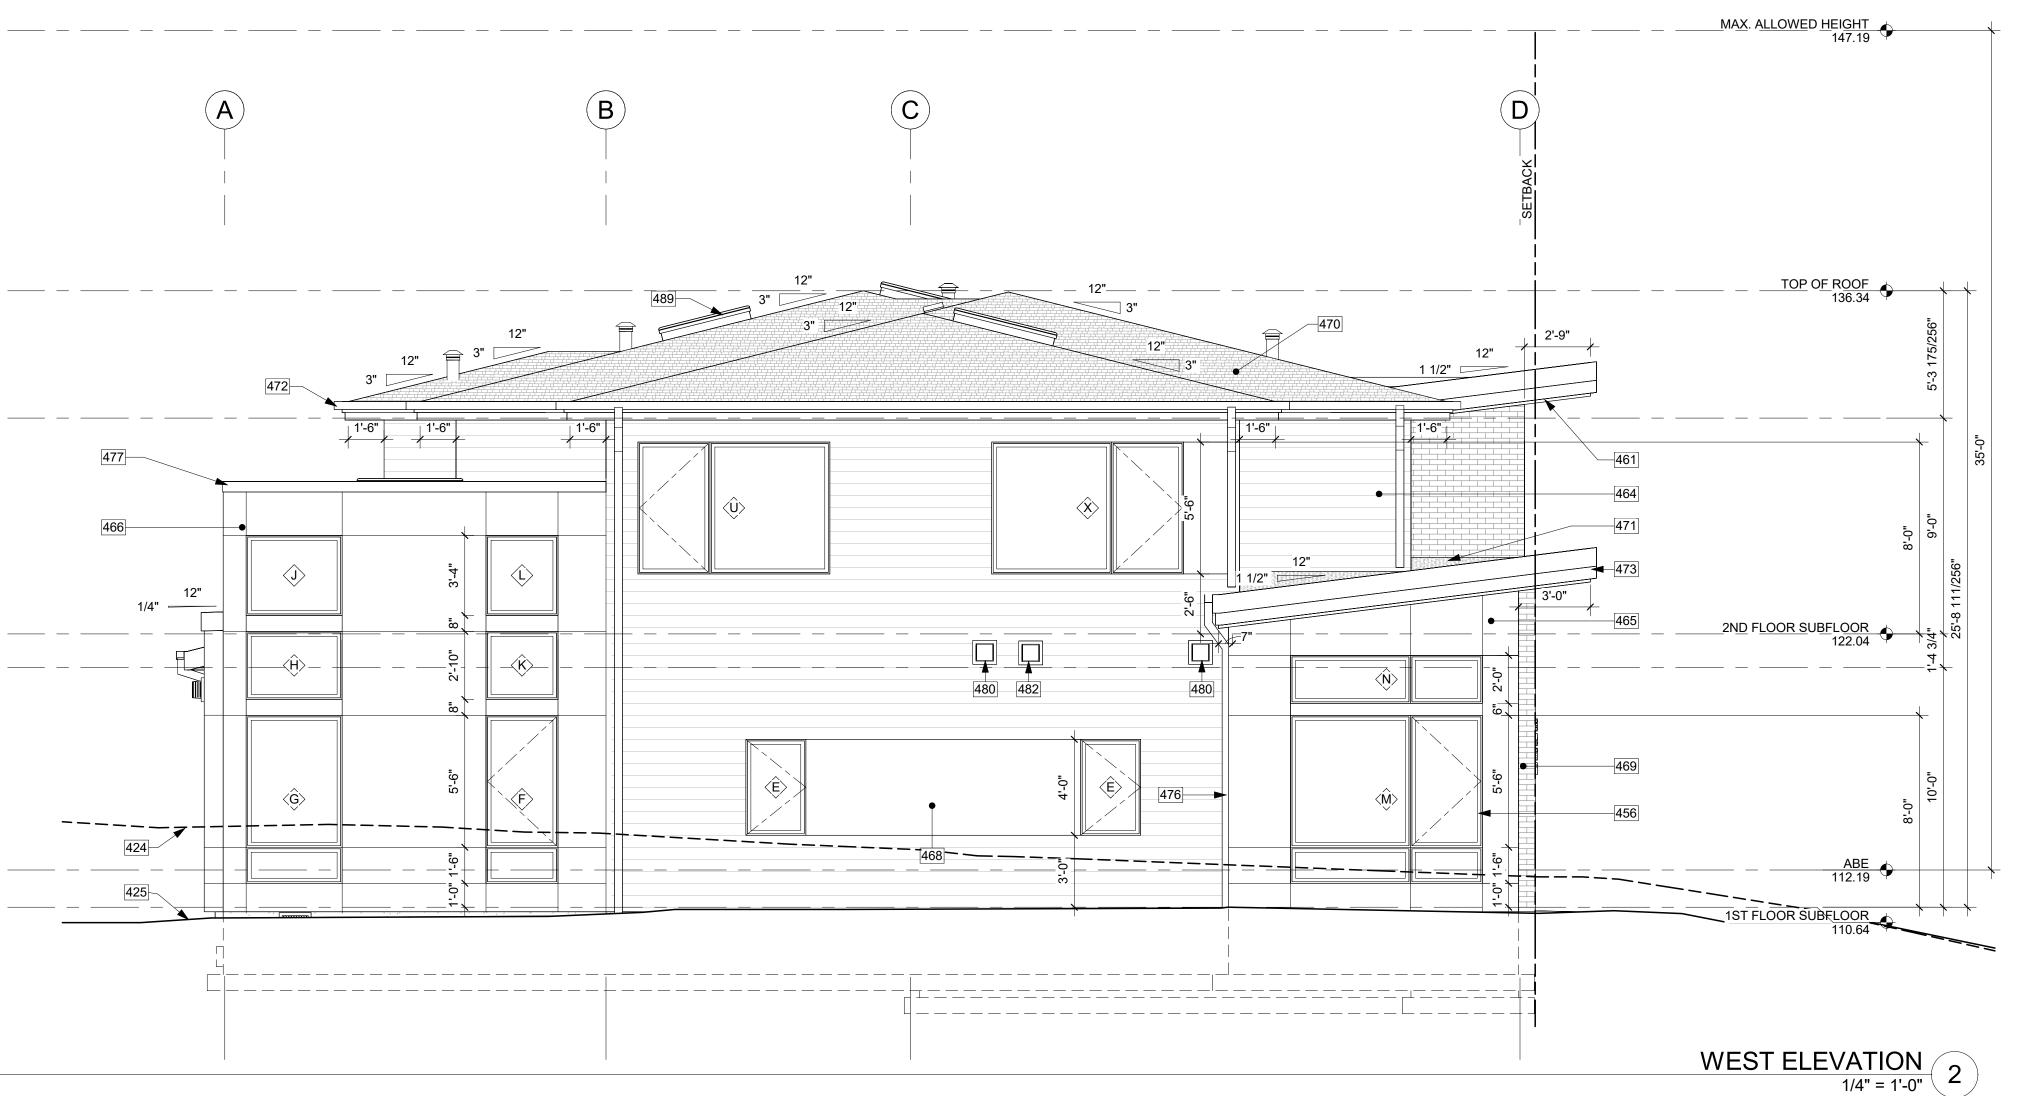- VERIFY SHEAR WALL NAILING & HOLDOWNS PER STRUCTURAL PLAN &
- SCHEDULE PRIOR TO INSTALLING SIDING. WOOD SIDING - SEAL & STAIN ALL SIDES BEFORE INSTALLING AND @ ALL
- WEATHER PROTECTION. EXTERIOR WALLS SHALL PROVIDE THE BUILDING WITH A WEATHER-RESISTANT EXTERIOR WALL ENVELOPE. THE EXTERIOR WALL ENVELOPE SHALL INCLUDE FLASHING AND BE CONSTRUCTED IN SUCH A MANNER AS TO PREVENT THE ACCUMULATION OF WATER WITHIN THE WALL ASSEMBLY BY PROVIDING A WATER-RESISTIVE BARRIER BEHIND THE EXTERIOR VENEER AND A MEANS FOR DRAINING WATER THAT ENTERS THE ASSEMBLY TO THE EXTERIOR. PROTECTION AGAINST
- CONDENSATION IN THE EXTERIOR WALL ASSEMBLY SHALL BE PROVIDED. PER IRC R703.8. FLASHING AT WALLS. FLASHING SHALL BE INSTALLED IN SUCH A MANNER SO AS TO PREVENT MOISTURE FROM ENTERING THE WALL OR TO REDIRECT THAT MOISTURE TO THE EXTERIOR. FLASHING SHALL BE INSTALLED AT THE PERIMETERS OF EXTERIOR DOOR AND WINDOW ASSEMBLIES, PENETRATIONS AND TERMINATIONS OF EXTERIOR WALL ASSEMBLIES, EXTERIOR WALL INTERSECTIONS WITH ROOFS, CHIMNEYS, PORCHES, DECKS, BALCONIES AND SIMILAR PROJECTIONS AND AT BUILT-IN GUTTERS AND SIMILAR LOCATIONS WHERE MOISTURE COULD ENTER THE WALL. FLASHING WITH PROJECTING FLANGES SHALL BE INSTALLED ON BOTH SIDES AND THE ENDS OF COPINGS, UNDER SILLS AND
- CONTINUOUSLY ABOVE PROJECTING TRIM. PROVIDE FLASHING AT ROOF PENETRATIONS PER IRC R903.2.1. FLASHING SHALL BE INSTALLED AT WALL AND ROOF INTERSECTIONS, AT GUTTERS, WHEREVER THERE IS A CHANGE IN ROOF SLOPE OR DIRECTION AND AROUND ROOF OPENINGS. WHERE FLASHING IS OF METAL, THE METAL SHALL BE CORROSION RESISTANT.
- PROVIDE CONTINUOUS GUTTERS & DOWNSPOUTS AT EAVES PER PLANS,
- PROVIDE WEATHER STRIPPING AT ALL EXTERIOR & GARAGE DOORS. CAULK ALL EXTERIOR JOINTS & PENETRATIONS.
- WINDOWS AND DOORS SHALL BE INSTALLED IN ACCORDANCE WITH APPROVED MANUFACTURER'S INSTRUCTIONS.
- SEE GENERAL NOTES SHEET A0.3 FOR ADDITIONAL NOTES.





KEY NOTES

- 424 LINE OF EXISTING GRADE.425 LINE OF PROPOSED GRADE.
- LANDINGS OR FINISHED FLOORS AT REQUIRED EGRESS DOORS SHALL NOT BE MORE THAN 1-1/2" LOWER THAN THE TOP OF THE THRESHOLD.
- LINE OF STAIRS AT EXTERIOR WALL.
- VINYL WINDOWS PER SCHEDULE. SAFETY GLAZING AND EGRESS WHERE NOTED.

 LIGHTING AT ALL EXTERIOR DOORS, TYP. PROVIDE BACKING FOR
- ATTACHMENT.

 LOCATION OF HOUSE ADDRESS OR NUMBER TO BE PLAINLY VISIBLE AND LEGIBLE FROM THE STREET, SIZE 6" HEIGHT FONT HELVETICA DARK
- DOORBELL "O" BUTTON LED ILLUMINATED POLYCARBONATE BASE & ALUMINUM FRONT MATCH WINDOW COLOR.
- TIGHT KNOT CEDAR T&G SOFFIT WITH 4" EXPOSURE, SEAL & STAIN ALL SIDES AND ALL CUTS BEFORE INSTALLING, TYP. PROVIDE 2-INCH CONTINUOUS
- STRIP SOFFIT VENT.

 TIGHT KNOT CEDAR T&G SIDING WITH 4" EXPOSURE, SEAL & STAIN ALL SIDES AND ALL CUTS BEFORE INSTALLING. INSTALL OVER FURRING STRIPS TO
- MATCH ADJACENT DEPTH OF SIDING MATERIALS.

 FIBER CEMENT PANEL, RAINSCREEN, PAINTED. NOTE: ALL FIBER CEMENT PANEL DIVISIONS TO ALIGN WITH WINDOWS AS SHOWN, TYP. NOTE:
- PAINTABLE XOCR TAMLYN SPLINE TO MATCH PANEL COLOR, TYP.

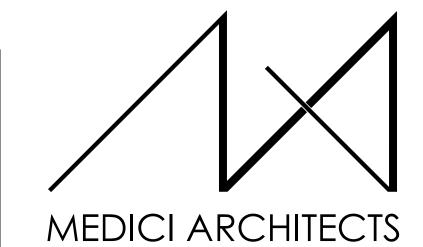
 466 FIBER CEMENT PLANK, HORIZONTAL LAP SIDING WITH 6" EXPOSURE, PAINTED COLOR TBD, TYP. NOTE: PAINTABLE XOCR TAMLYN SPLINE TO MATCH PANEL COLOR, TYP.
- 468 FIBER CEMENT PANEL INFILL, PAINTED; MATCH WINDOW COLOR
 469 STONE VENEER, DRY STACK.
- 470 ASPHALT SHINGLE ROOF. ROOFING SYSTEM PER SRC R905.2.
- TPO ROOFING INSTALLED PER MANUFACTURER. PER TABLE R905.1.1(2), DOUBLE LAYER OF UNDERLAYMENT REQUIRED IF ROOF PITCH IS SHALLOWER THAN 4:12.
- 472 4" SQUARE GUTTER OVER 2X6 OVER 2X10 STEPED FASCIA, PRIMED,
- FINGER-JOINTED CEDAR FASCIA BOARD.

 2X10 OVER 2X16 STEPED PAINTED WOOD FASCIA, COLOR BLACK, WITH 20 GA.
- POWDER COATED METAL FLASHING WITH CONTINUOUS CLEAT.

 475 POWDER-COATED SCUPPER AND 4" SQUARE DOWNSPOUT. TIGHTLINE ALL DOWNSPOUTS TO STORMWATER SYSTEM, PER CIVIL.
- 476 4" SQUARE DOWNSPOUT. TIGHTLINE ALL DOWNSPOUTS TO STORMWATER SYSTEM, PER CIVIL.
- 477 20 GA., POWDER COATED METAL COPING. PROVIDE CONTINUOUS STRIP VENT
- PER DETAILS, TYP.

 480 STOVE & COOKTOP HOOD VENT TERMINATION. VERIFY 3'-0" MINIMUM
- CLEARANCE FROM GLAZING.

 482 EXHAUST VENT. VERIFY 3'-0" MINIMUM CLEARANCE FROM GLAZING.
- 487 ALIGN WINDOW AND DOOR JAMBS.
 489 2X6 WOOD-FRAMED WRAPPED BY STONE VENEER PARAPET WITH STONE CAP FLASHING.
- 490 SKYLIGHT PER SCHEDULE, TYP. INSTALL WITH CURB AND FLASHING PER STRUCTURAL AND MANUFACTURER.




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STREET 200 W. RIVER ST. SUITE 301 \$ 98005 KETCHUM, ID 83340 9298 TEL: (208) 726-0194

REGISTRATION:

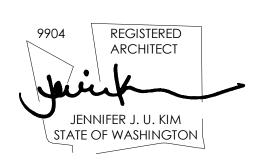INTAKE DATE:



07-26-2023

REVISIONS: DATE:

PROJECT / CLIENT:

LYNNWOOD HOUSE 2

TRIAD HOMES

PROJECT ADDRESS: 3521 169TH AVE SW LYNNWOOD, WA 98037

DRAWING NAME:

ELEVATIONS

DRAWN BY: KKH
CHECKED By: JK

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ADU LAND USE PERMTI

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APPROVED FOR CONSTRUCTION:

PROJECT No.: A21 069

A4.

PLOT SCALE: 1:1

DATE: 7/26/2023

ELEVATION NOTES

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- SCHEDULE PRIOR TO INSTALLING SIDING.
 2. WOOD SIDING SEAL & STAIN ALL SIDES BEFORE INSTALLING AND @ ALL
- 3. WEATHER PROTECTION. EXTERIOR WALLS SHALL PROVIDE THE BUILDING WITH A WEATHER-RESISTANT EXTERIOR WALL ENVELOPE. THE EXTERIOR WALL ENVELOPE SHALL INCLUDE FLASHING AND BE CONSTRUCTED IN SUCH A MANNER AS TO PREVENT THE ACCUMULATION OF WATER WITHIN THE WALL ASSEMBLY BY PROVIDING A WATER-RESISTIVE BARRIER BEHIND THE EXTERIOR VENEER AND A MEANS FOR DRAINING WATER THAT ENTERS THE ASSEMBLY TO THE EXTERIOR. PROTECTION AGAINST
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 4. PER IRC R703.8. FLASHING AT WALLS. FLASHING SHALL BE INSTALLED IN SUCH A MANNER SO AS TO PREVENT MOISTURE FROM ENTERING THE WALL OR TO REDIRECT THAT MOISTURE TO THE EXTERIOR. FLASHING SHALL BE INSTALLED AT THE PERIMETERS OF EXTERIOR DOOR AND WINDOW ASSEMBLIES, PENETRATIONS AND TERMINATIONS OF EXTERIOR WALL ASSEMBLIES, EXTERIOR WALL INTERSECTIONS WITH ROOFS, CHIMNEYS, PORCHES, DECKS, BALCONIES AND SIMILAR PROJECTIONS AND AT BUILT-IN GUTTERS AND SIMILAR LOCATIONS WHERE MOISTURE COULD ENTER THE WALL. FLASHING WITH PROJECTING FLANGES SHALL BE INSTALLED ON BOTH SIDES AND THE ENDS OF COPINGS, UNDER SILLS AND
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- PROVIDE CONTINUOUS GUTTERS & DOWNSPOUTS AT EAVES PER PLANS, TYP.
 PROVIDE WEATHER STRIPPING AT ALL EXTERIOR & GARAGE DOORS.

SHALL BE CORROSION RESISTANT.


- CAULK ALL EXTERIOR JOINTS & PENETRATIONS.

 8. WINDOWS AND DOORS SHALL BE INSTALLED IN ACCORDANCE WITH
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 SEE GENERAL NOTES SHEET A0.3 FOR ADDITIONAL NOTES.



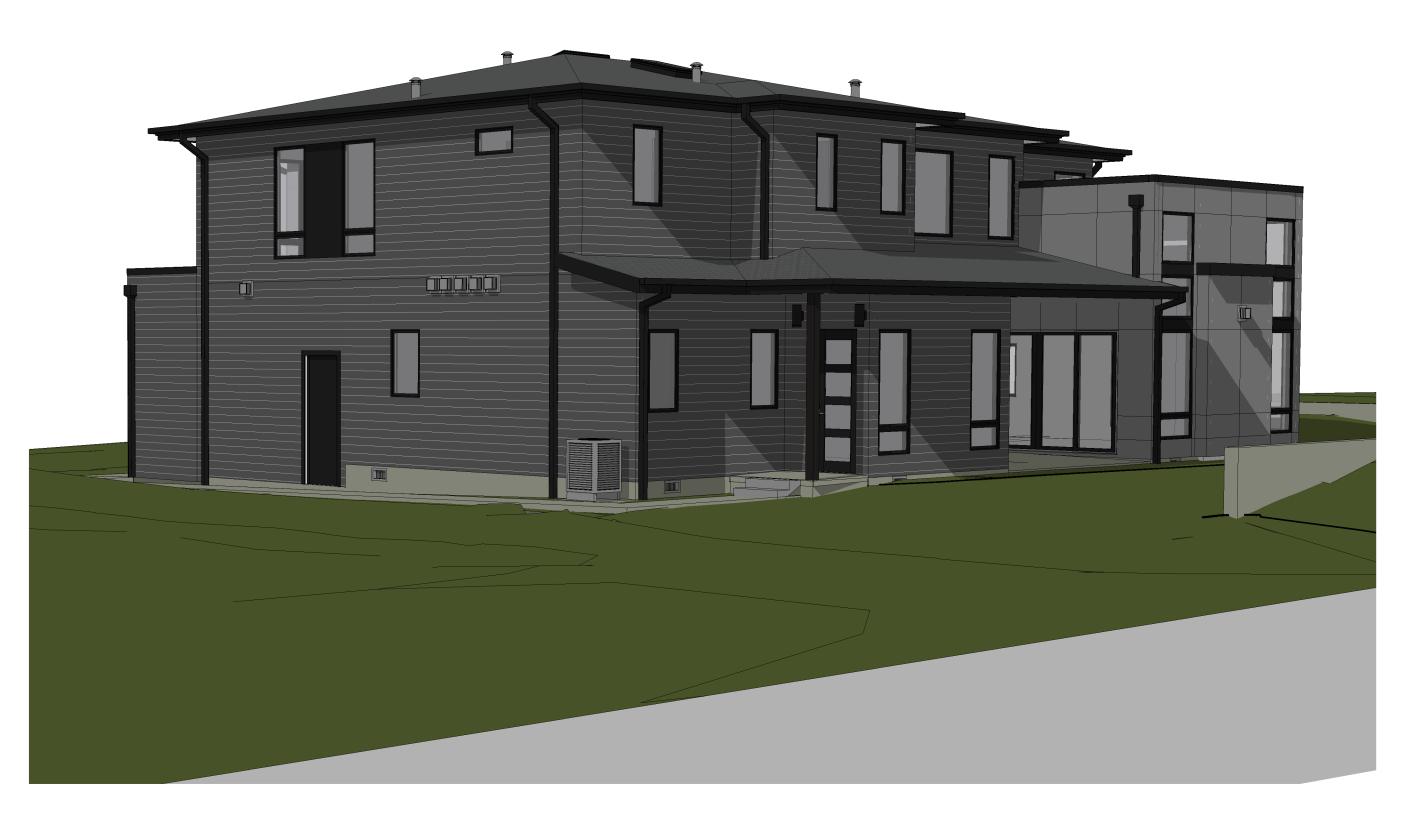
PERSPECTIVE 1



PERSPECTIVE 2

NTS

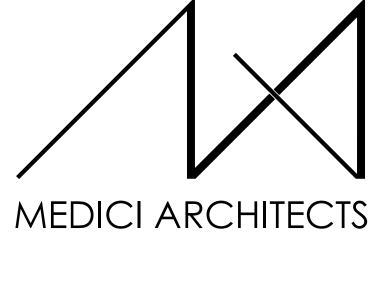
PERSPECTIVE 4



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LYNNWOOD HOUSE 2

TRIAD HOMES

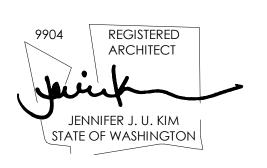PROJECT ADDRESS: 3521 169TH AVE SW LYNNWOOD, WA 98037

DRAWING NAME:

PERSPECTIVES

DRAWN BY: KKH CHECKED By: JK

PHASE:

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PERSPECTIVE 3







MAX. ALLOWED HEIGHT 147.19

MAX. ALLOWED HEIGHT 147.19

COMPOSITION SHINGLE ROOFINGGAF CHARCOAL OR SIMILAR



FIBER CEMENT PANEL SIDING

• SMOOTH TEXTURE



FIBER CEMENT LAP SIDINGSMOOTH TEXTURE, 7" REVEAL



FIBER CEMENT PANEL SIDINGSMOOTH TEXTURE



VINYL WINDOWDARK BRONZE EXTERIOR FINISH




BRICK VENEER (SFR ONLY)MUTUAL MATERIALS SLIM BRICK, COAL CREEK OR SIMILAR



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LYNNWOOD HOUSE 2

TRIAD HOMES

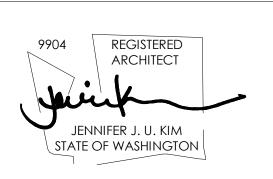PROJECT ADDRESS: 3521 169TH AVE SW LYNNWOOD, WA 98037

DRAWING NAME: **ELEVATIONS -**MATERIALS/COLORS

DRAWN BY: KKH CHECKED By: JK

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MAX. ALLOWED HEIGHT 147.19

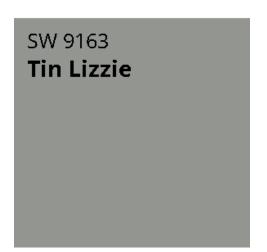


ADU NOT VISIBLE IN THESE ELEVATIONS, BUT SHOWN FOR MATERIAL REFERENCE OF MAIN STRUCTURE






COMPOSITION SHINGLE ROOFINGGAF CHARCOAL OR SIMILAR



FIBER CEMENT PANEL SIDING

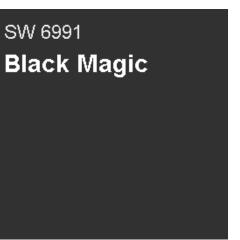• SMOOTH TEXTURE





FIBER CEMENT PANEL SIDINGSMOOTH TEXTURE

VINYL WINDOWDARK BRONZE EXTERIOR FINISH



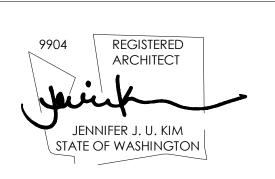
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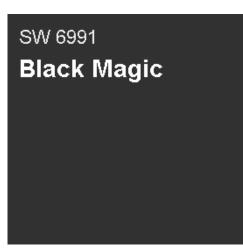


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FIBER CEMENT LAP SIDINGSMOOTH TEXTURE, 7" REVEAL





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